


# CLEVELAND - CUYAHOGA COUNTY PORT AUTHORITY

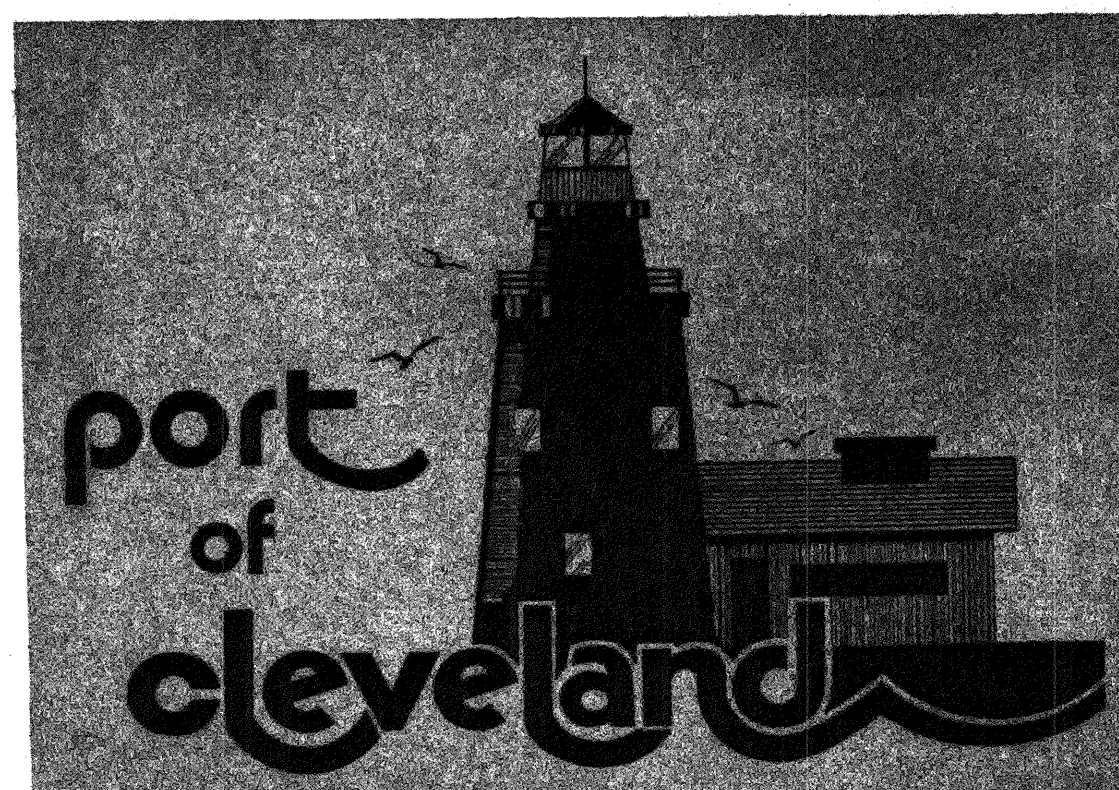

## DOCK 24W SLIP EXTENSION

JANUARY, 1992

REPRINTED CONSTRUCTION  
ISSUE REVISED TO  
INCLUDE REV. WATER  
DESIGN SHT. 11  
PGP  
5/96


### LIST OF DRAWINGS

- 1) COVER SHEET
- 2) DESIGN CRITERIA AND GENERAL NOTES
- 3) GENERAL SITE PLAN
- 4) DEMOLITION PLAN
- 5) CONSTRUCTION PLAN
- 6) DREDGE SECTIONS
- 7) SHEETPILE WALL SECTIONS
- 8) STRUCTURAL DETAILS AND SECTIONS
- 9) ADDITIONAL MARINE DETAILS
- 10) MISCELLANEOUS DETAILS
- 11) UTILITIES PLAN
- 12) UTILITY DETAILS
- 12A) UTILITY DETAILS
- 13) UTILITY DETAILS

#### UNDERGROUND UTILITIES

TWO WORKING DAYS  
BEFORE YOU DIG  
CALL 800-362-2764 (TOLL FREE)  
OHIO UTILITIES PROTECTION SERVICE

NON-MEMBERS  
MUST BE CALLED DIRECTLY

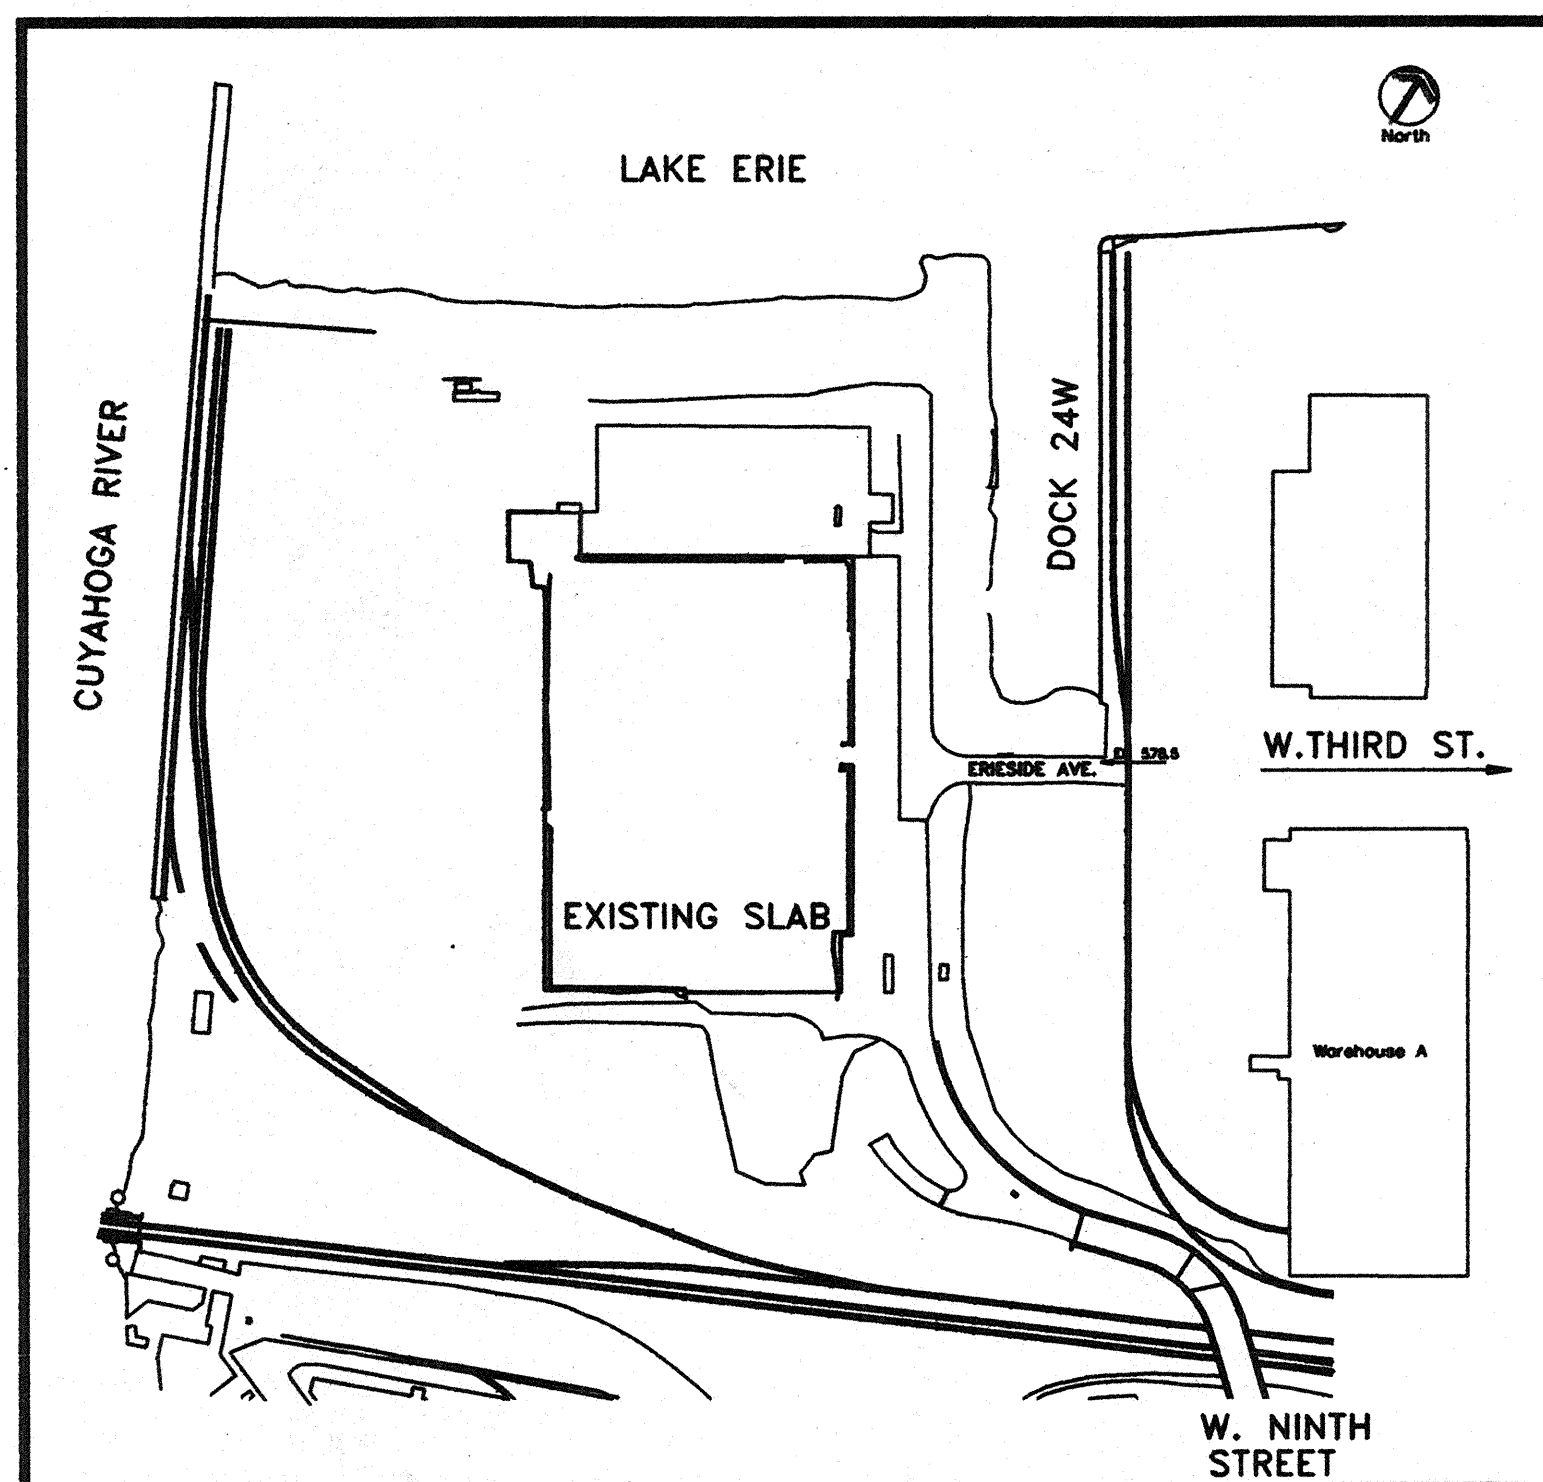

### LOCATION PLAN

NOTE: ALL ELEVATIONS IN CRGS DATUM. FOR  
IGLD DATUM SUBTRACT 1.7'

Turner  
URS CONSULTANTS  
POLYTECH

### BOARD OF DIRECTORS

JAY C. EHLE (CHAIRMAN)  
THOMAS E. WAGNER (VICE CHAIRMAN)  
REVEREND STERLING E. GLOVER (SECRETARY)  
ELLA H. BECTON  
HOWARD W. BROADBENT  
WILLIAM J. McCARTHY  
RENOLD D. THOMPSON  
CARLA M. TRICARICHI


APPROVED BY \_\_\_\_\_ DATE \_\_\_\_\_  
ANTHONY F. FUGARO, EXEC. DIRECTOR

APPROVED BY \_\_\_\_\_ DATE \_\_\_\_\_  
JAY C. EHLE, CHAIRMAN OF THE BOARD


**BULKHEAD DESIGN CRITERIA  
VERTICAL DESIGN LOAD**

1.) DESIGN UNIFORM LIVE LOAD 1000 PSF  
(SURCHARGE = 1000 PSF)


2.) RAILROAD LOCOMOTIVE (COOPER E 80)

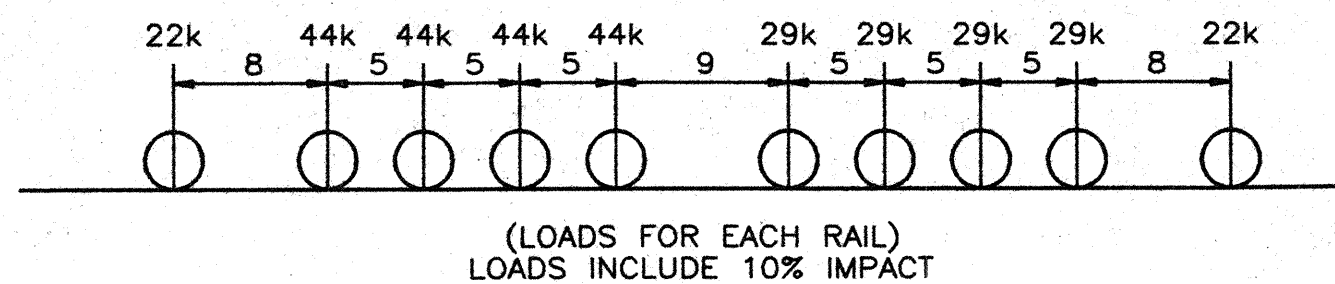

3.) CRAWLER CRANE 4600 S-5  
FOOT PRINT LOADING 6 KSF  
(LIFTING 50T @ SHIP CENTERLINE)

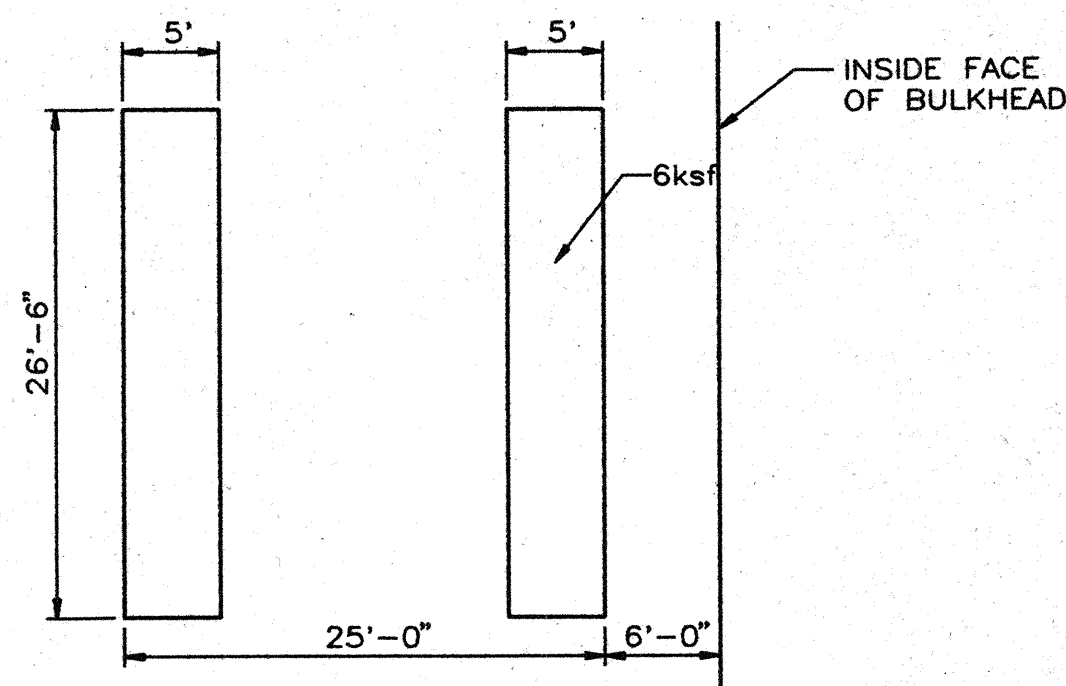


4.) 35 TON LIFT TRUCK

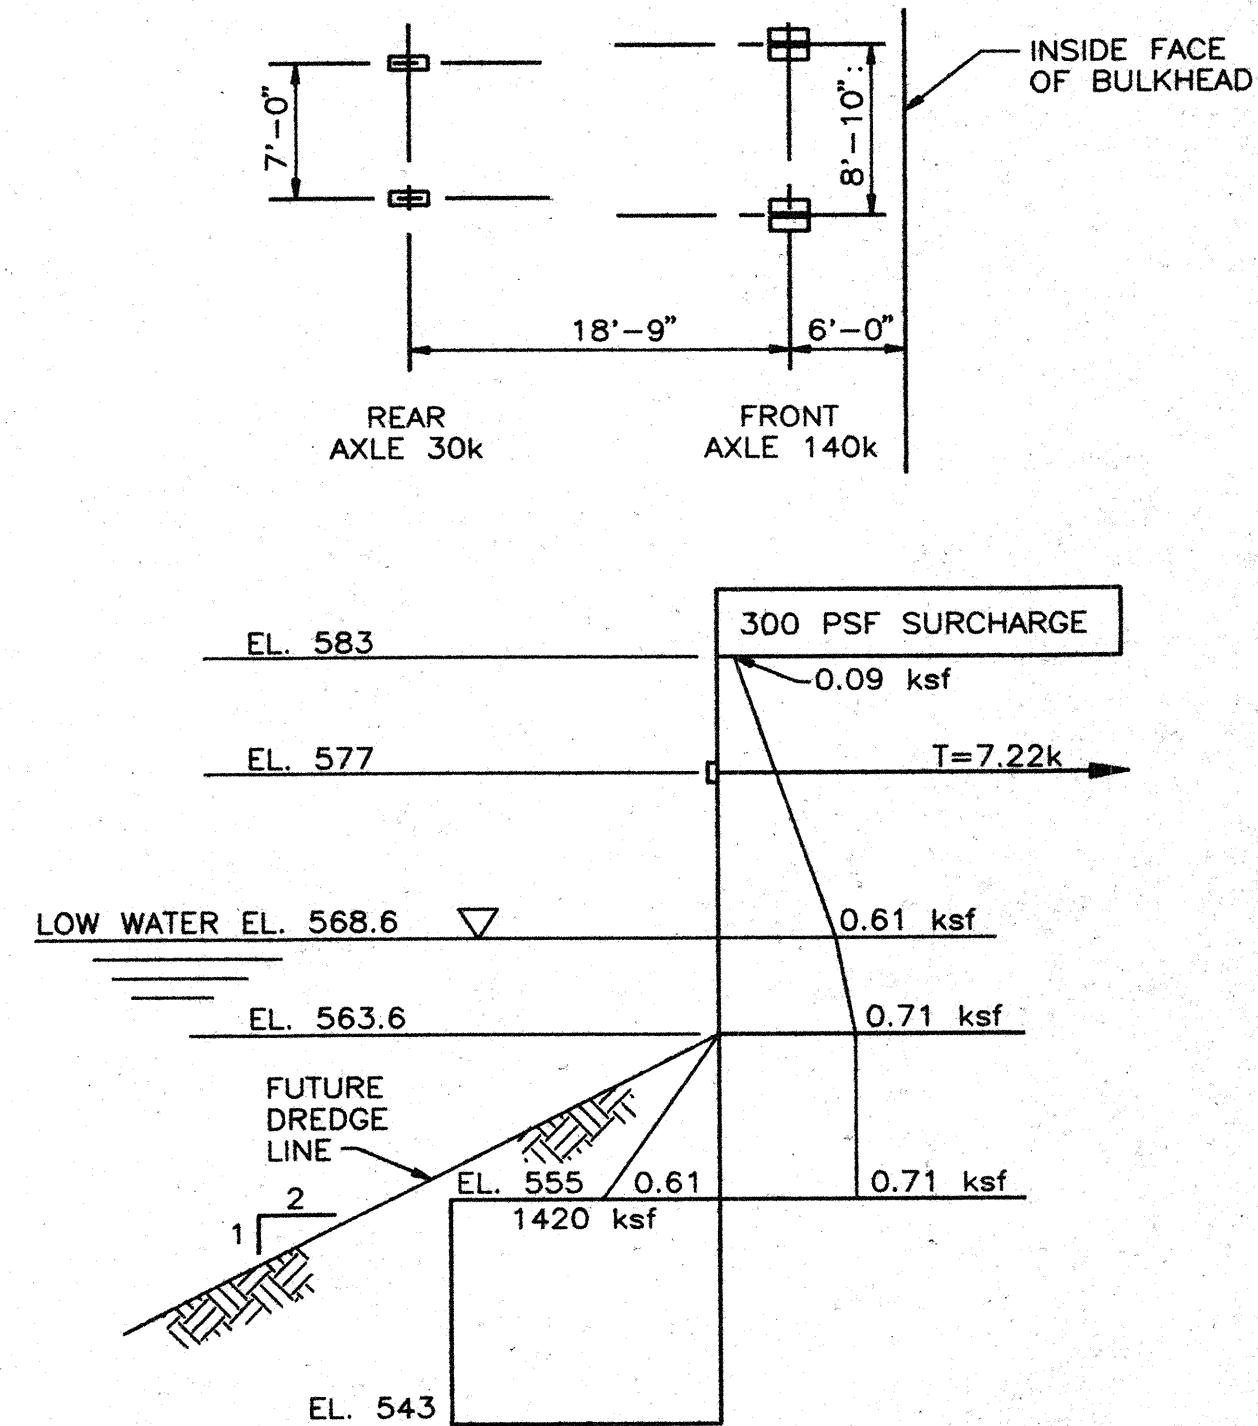


**BULKHEAD DESIGN PRESSURE DIAGRAM  
FOR ERIE AVENUE BULKHEAD**

**BULKHEAD DESIGN CRITERIA  
LATERAL LOADING**

1.) LATERAL DESIGN LOADS BERTHING  
VESSEL 25,000 DWT

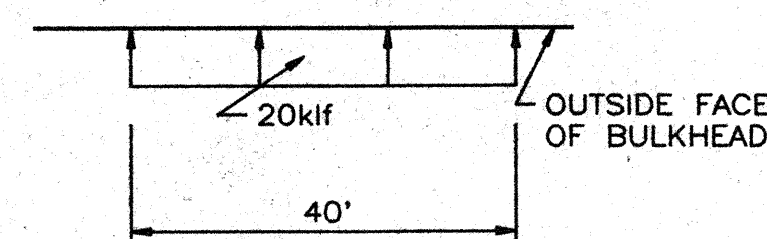


2.) MOORING LINE FORCES  
BOLLARD PULL P = 150 KIPS  
BOLLARDS ARE AT 60° ON CENTER

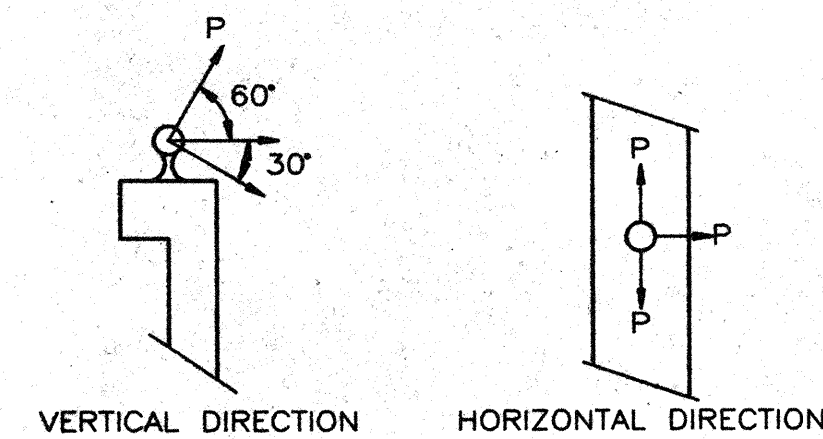

3.) SEISMIC ZONE 1  
OHIO BASIC BUILDING CODE - 1989

4.) DESIGN WIND SPEED 90 MPH  
OHIO BASIC BUILDING CODE - 1989

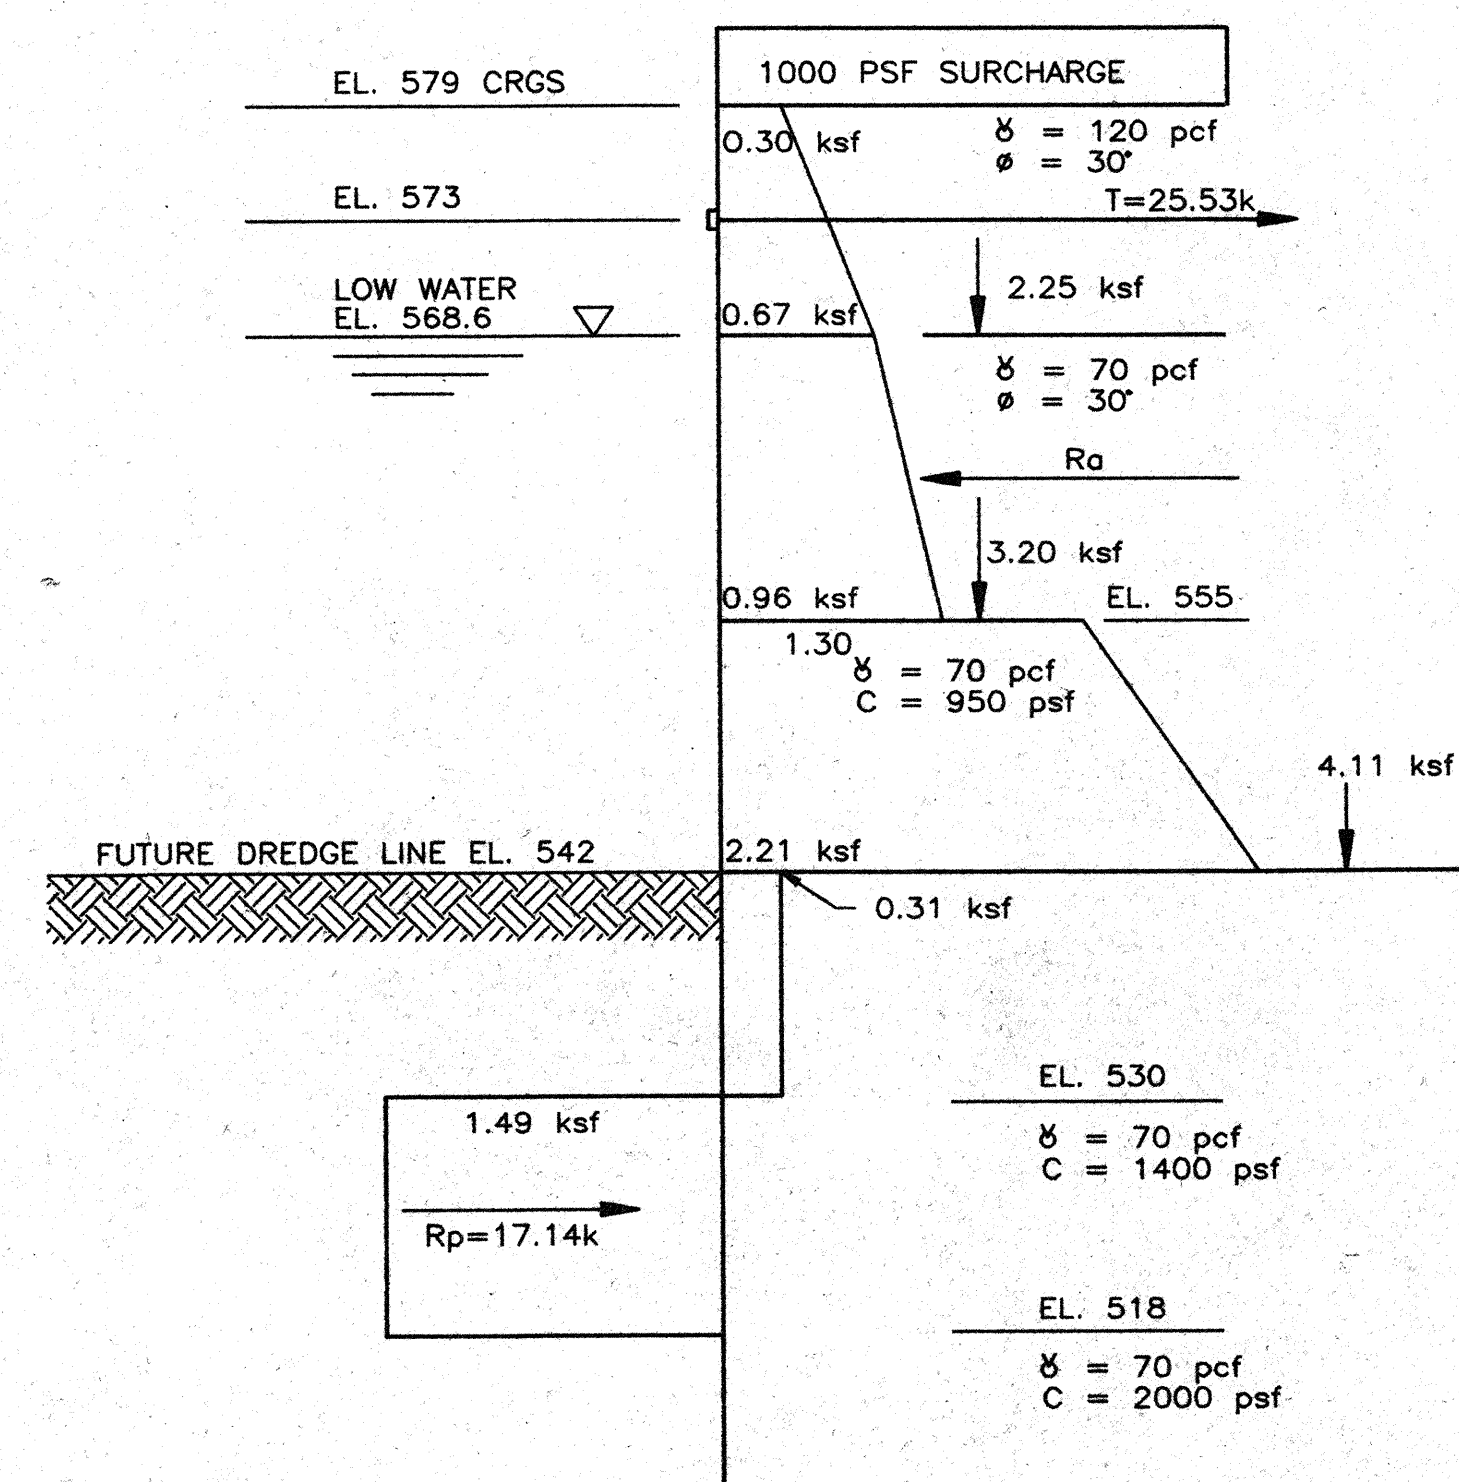

**BULKHEAD DESIGN PRESSURE DIAGRAM  
FOR 24W EXTENSION**

**GENERAL NOTES:**


- 1.) THE FOLLOWING NOTES WILL APPLY TO ALL STRUCTURAL/CIVIL WORK ON THIS PROJECT.
- 2.) FIELD VERIFY ALL DIMENSIONS.

**REINFORCED CONCRETE**

- 1.) FORMED SURFACES SHALL BE FREE OF AIR POCKETS OR HONEYCOMBS.
- 2.) REINFORCING BARS SHALL CONFORM TO ASTM SPECIFICATION A615 (DEFORMED BAR), GRADE 60.
- 3.) ALL HOOKS SHALL BE "ACI STANDARD" UNLESS SHOWN OTHERWISE.
- 4.) CUT AND HOOK OR DEFLECT BARS AT OPENINGS, AS REQUIRED.
- 5.) MINIMUM REBAR SPLICE TO BE 36 BAR DIAMETERS.
- 6.) UNLESS NOTED OTHERWISE, CHAMFER ALL EXPOSED CORNERS 3/4".
- 7.) NON-FORMED SURFACES SHALL HAVE A STEEL TROWEL FINISH.

**SUGGESTED TIE BAR INSTALLATION**

- 1.) EXCAVATE CONSTRUCTION AREA TO 2 FT. ABOVE TIE BAR LEVEL.
- 2.) EXCAVATE TIE BAR TRENCHES 2 FT. 4 IN. WIDE, 3 FT. DEEP.
- 3.) INSTALL TIE BAR.
- 4.) INSTALL AND COMPACT GRANULAR BACKFILL MATERIAL IN 8 INCH LIFTS TO TOP OF TRENCH.
- 5.) COMPLETE AREA BACKFILL, LEAVING ACCESS FOR PRE-TENSIONING OF TIE BARS.
- 6.) PRE-TENSION BARS.
- 7.) COMPLETE BACKFILLING AND COMPACTING.

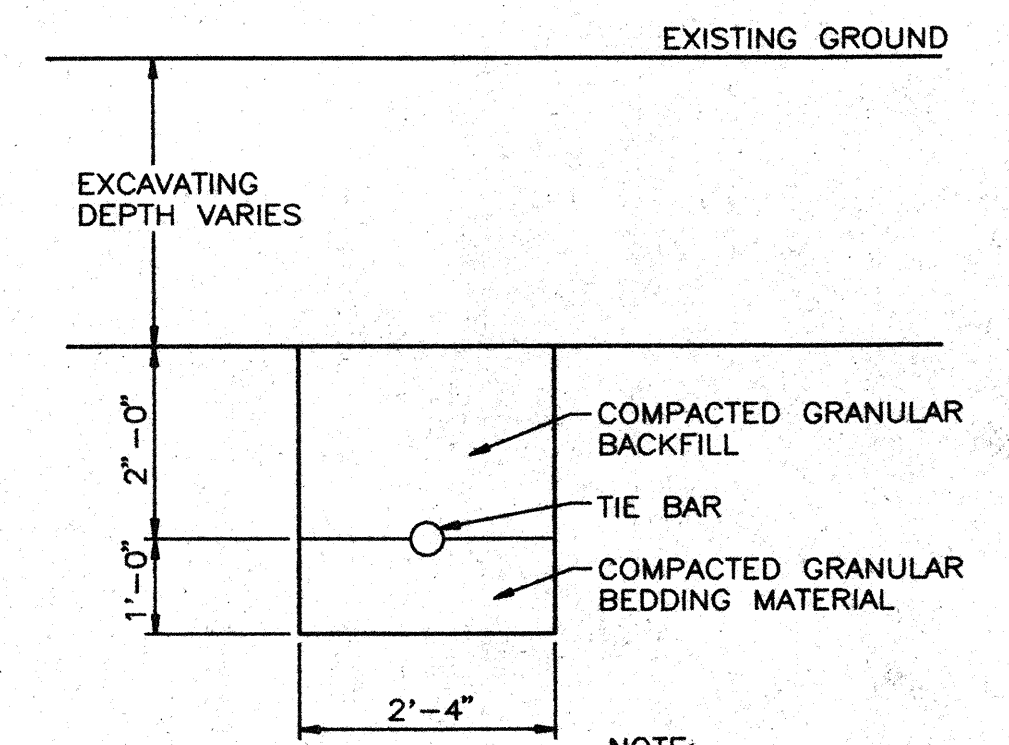

NOTE:  
BEDDING AND FIRST LIFT  
OF BACKFILL SHALL BE  
FREE OF SHARP EDGED  
STONE.

**TIE BAR INSTALLATION**

**STRUCTURAL AND MISCELLANEOUS STEEL**

- 1.) ALL STRUCTURAL STEEL SHALL CONFORM TO ASTM SPECIFICATION A36. UNLESS NOTED OTHERWISE.
- 2.) SHEET PILE STEEL SHALL CONFORM TO ASTM SPECIFICATION A572-GRADE 50.
- 3.) MATERIALS, WORKMANSHIP, FABRICATION, ERECTION AND CONNECTION DESIGN SHALL CONFORM TO "A.I.S.C. SPECIFICATIONS FOR THE DESIGN, FABRICATION AND ERECTION OF STRUCTURAL STEEL FOR BUILDINGS", EIGHTH EDITION.
- 4.) ALL BOLTED CONNECTIONS SHALL BE BEARING TYPE WITH THREADS INCLUDED IN SHEAR PLANE, AND MADE WITH 1 1/4" & 1 3/4" HIGH STRENGTH GALVANIZED BOLTS CONFORMING TO ASTM SPECIFICATION A325, UNLESS NOTED OTHERWISE. HOLES FOR BOLTS SHALL BE 1/16" LARGER THAN THE NORMAL DIAMETER OF THE BOLT.
- 5.) ALL WELDING SHALL BE DONE BY A.W.S. CERTIFIED WELDERS USING ELECTRODES CONFORMING TO A.W.S. SPECIFICATION A5.1 OR A5.5 CLASS E70XX SERIES.
- 6.) FIELD CONNECTIONS SHALL BE BOLTED UNLESS SHOWN OTHERWISE. SHOP CONNECTIONS SHALL BE BOLTED OR WELDED.
- 7.) STEEL PIPE SHALL BE STANDARD WEIGHT CONFORMING TO ASTM SPECIFICATION A501 OR A53 TYPE E OR S GRADE "B", UNLESS SHOWN OTHERWISE. JOINTS SHALL BE WELDED AND GROUND SMOOTH.
- 8.) ALL STRUCTURAL STEEL SUCH AS WALERS & BOLLARD SHALL BE SHOP PRIMED WITH AN INORGANIC ZINC PRIMER TO 2.5 MIL MINIMUM THICKNESS AND FIELD PAINTED WITH A HIGH BUILD POLYURETHANE EPOXY TO A MINIMUM OF 5 MIL DRY THICKNESS, COLOR PER OWNER'S SPECIFICATION.
- 9.) ALL SPLICES SHALL BE DESIGNED TO DEVELOP THE FULL STRENGTH OF THE MEMBERS, EXCEPT AS DETAILED.
- 10.) ALL CONNECTION HARDWARE INCLUDING CUT WASHERS AND FABRICATED CONNECTION ASSEMBLIES, SHALL CONFORM TO ASTM A36 STEEL.
- 11.) TIE BACK BARS SHALL CONFORM TO ASTM SPECIFICATION A722 GRADE 150.
- 12.) PILES FOR BOLLARDS SHALL BE 12 3/4" O.D.x.375" WALL THICKNESS, ASTM 252, GRADE 2.
- 13.) ALL MISCELLANEOUS STEEL SUCH AS BOLTS, NUTS, WASHER PLATES AND DOCK FENDER CHAIN SYSTEM SHALL BE HOT-DIP GALVANIZED. SEE SPECIFICATIONS.

**MISCELLANEOUS**

- 1.) ALL HEAVY TIMBER IN THE BULLRAIL SYSTEM SHALL BE NO.1 STRUCTURAL GRADE DOUGLAS FIR AND SHALL BE PRESSURE TREATED WITH CCA WATER-BORNE PRESERVATIVE IN ACCORDANCE WITH AWPA STANDARD C-2. FOR STORING AND HANDLING, USE AWPA STANDARD M4. FOR FIELD BORED HOLES, USE PRESSURE HOLE TREATER.
- 2.) TIEBACK RODS SHALL BE TAR COATED AS SHOWN IN NOTE 2, SHEET 7.
- 3.) GROUT UNDER ALL BASE PLATES AND EQUIPMENT PADS SHALL BE NON-SHRINK NON-METALLIC AND HAVE MINIMUM 28 DAYS STRENGTH OF 6500 PSI.
- 4.) ANCHOR BOLTS AND EMBEDDED METALS SHALL CONFORM TO ASTM SPECIFICATION A307 OR A36 RESPECTIVELY UNLESS NOTED OTHERWISE.
- 5.) ALL CONCRETE ANCHORS FOR EMBEDDED METALS SHALL BE WELDED PER MANUFACTURER'S INSTRUCTIONS TO DEVELOP THE FULL STRENGTH OF ANCHOR STUD OR REBAR.
- 6.) PVC PIPE SHALL CONFORM TO ASTM SPECIFICATION D1785.
- 7.) SHOP DRAWINGS: CONTRACTOR SHALL COORDINATE THE SUBMITTAL OF SHOP DRAWINGS WITH THE ENGINEER. CONTRACTOR SHALL PROVIDE THE ENGINEER WITH A SCHEDULE OF SHOP DRAWINGS WITHIN TWO WEEKS AFTER RECEIVING NOTICE TO PROCEED. PROVIDE THE ENGINEER ONE (1) REPRODUCIBLE COPY AND TWO (2) PRINTED COPIES OF ALL SHOP DRAWINGS.
- 8.) SCHEDULE OF VALUES: CONTRACTOR SHALL PROVIDE A SCHEDULE OF VALUES PROVIDING A LABOR AND MATERIAL COST BREAKDOWN IN ACCORDANCE WITH AIA 6703 FORMAT. SCHEDULE OF VALUES TO BE SUBMITTED TO THE ENGINEER FOR HIS APPROVAL WITHIN FOURTEEN (14) DAYS OF NOTICE TO PROCEED.
- 9.) CONTRACTOR SHALL COORDINATE WITH THE ENGINEER THE USE OF THE OWNER'S TRUCK SCALE FOR PURPOSES OF MEASURING EXCAVATED MATERIAL REMOVED FROM THE SITE. MEASUREMENTS SHALL BE USED BY THE ENGINEER IN APPROVING CONTRACTOR'S APPLICATION FOR PAYMENT.

No.	Date	By	Revision
2	3/4/92	WAJ	APPROVED FOR CONSTRUCTION ADDENDUM #3
1	1/7/92	WAJ	BID ISSUE ONLY
A	5/8/91	WAJ	FOR CLIENT REVIEW

Turner  
URS CONSULTANTS  
POLYTECH

DESIGNED BY: WAJ	DATE: 5/8/91
DRAWN BY: H.HOLT	DATE: 5/8/91
CHECKED BY: DSP	DATE: 5/21/91
SCALE 1" = 100'	

DOCK 24W SLIP EXTENSION  
CLEVELAND-CUYAHOGA COUNTY  
PORT AUTHORITY


ANTHONY F. FUGARD, EXEC. DIRECTOR  
JAY C. EHLE, CHAIRMAN OF THE BOARD

DESIGN CRITERIA AND  
GENERAL NOTES

PROJECT NO. 8921300

**NOTES**

- 1) FOR UTILITIES SEE SHEETS 11, 12, 12A, AND 13.
- 2) RAILROAD - ALL RAIL TO BE REINSTALLED, AS WELL AS TIES IN GOOD CONDITION (AS DETERMINED BY THE ENGINEER).
- 3) EXISTING ELECTRIC/LIGHT POLES WITHIN LIMITS OF WORK TO BE REMOVED BY OTHERS.
- 4) REMOVE ALL BROKEN CONCRETE AND LARGE BOULDERS FROM EXISTING SLOPE, AND PLACE ON FACE OF NEW SLOPE TO PROTECT AGAINST WAVE ACTION.

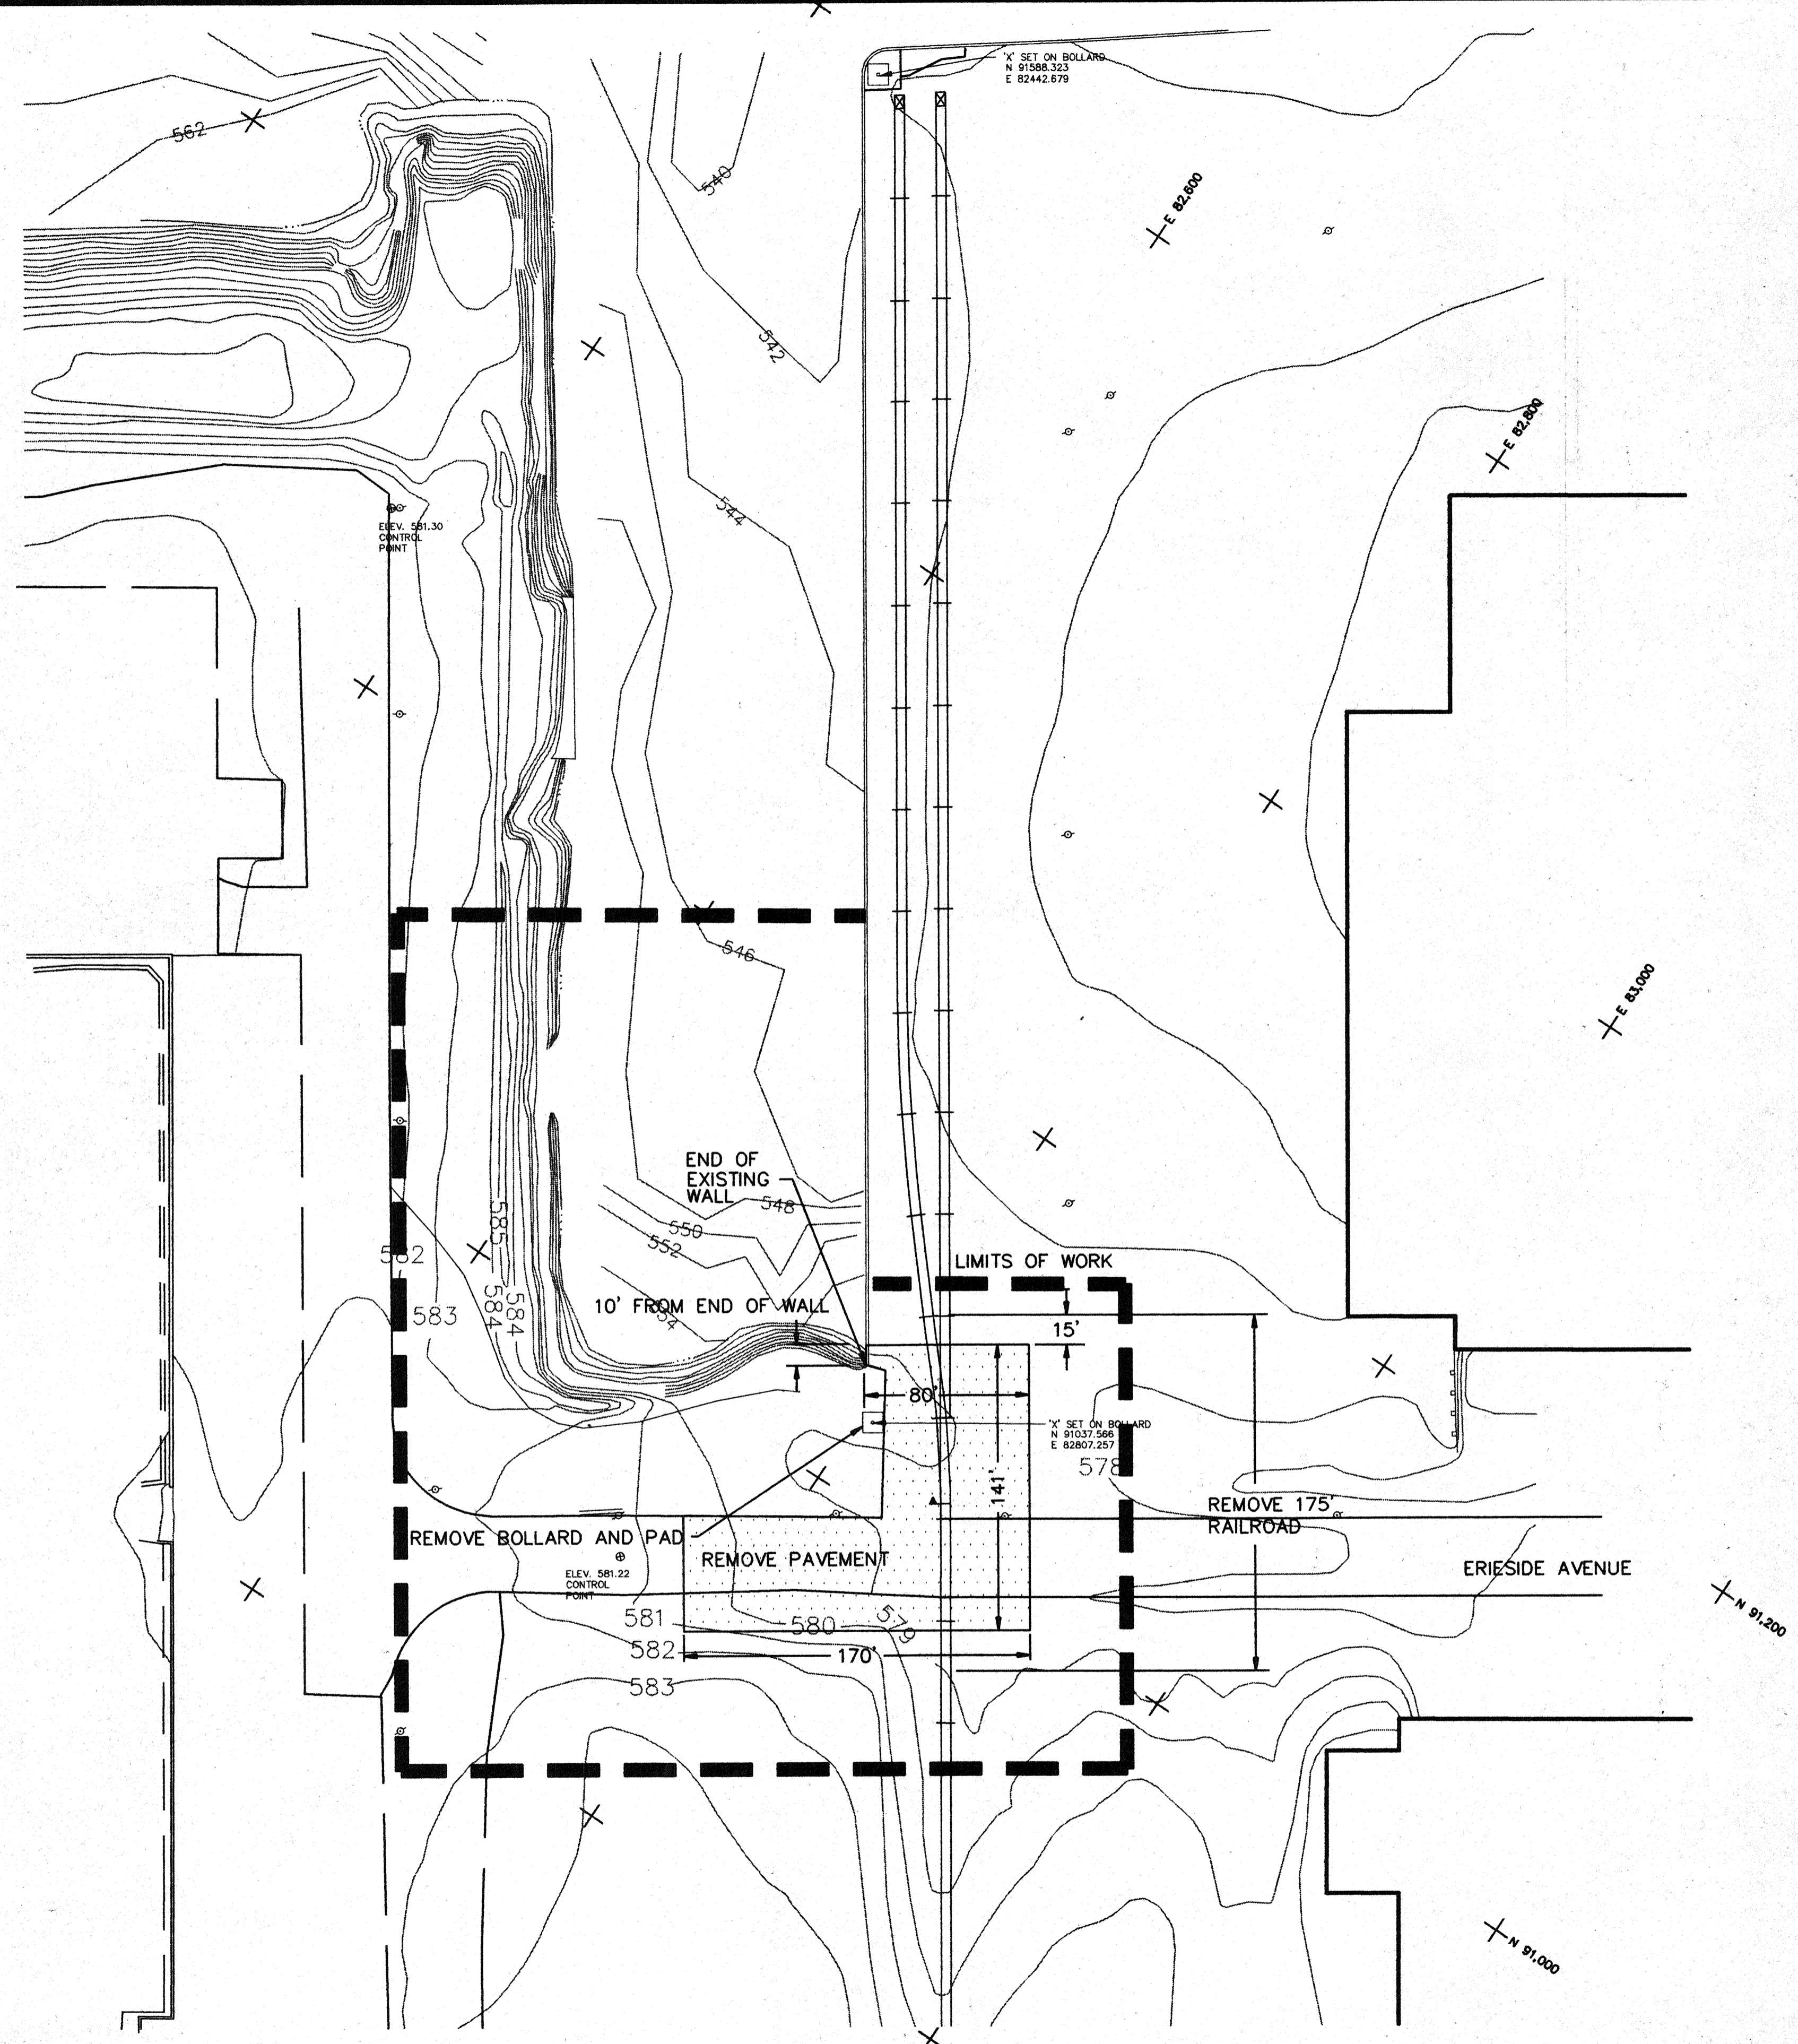

No.	Date	By	Revision
2	3/4/92	PGP	APPROVED FOR CONSTRUCTION
1	1/13/92	PGP	BID ISSUE ONLY

Turner  
URS CONSULTANTS  
POLYTECH

DESIGNED BY:  
PGP

DRAWN BY:  
PGP

CHECKED BY:  
DSP

DATE:  
5/15/91

DATE:  
5/21/91

DATE:  
7/17/91

SCALE  
1" = 50'

DOCK 24W SLIP EXTENSION  
CLEVELAND-CUYAHOGA COUNTY  
PORT AUTHORITY


ANTHONY F. FUGARO, EXEC. DIRECTOR  
JAY C. EHLE, CHAIRMAN OF THE BOARD

DEMOLITION PLAN

PROJECT NO. 8921300

**NOTES**

- 1) GRADE PAVEMENT TOWARDS DOCK.
- 2) REPLACE PAVEMENT TO MEET EXISTING EDGES AND NEW RAILROAD.
- 3) REPLACE RAILROAD TO MEET EXISTING ELEVATIONS AT EACH END.
- 4) DREDGE LIMITS SHALL BE CONSIDERED TO BE AT ELEVATION 572 AND BELOW. ALL EARTHWORK ABOVE ELEVATION 572 SHALL BE CONSIDERED NORMAL EXCAVATION.
- 5) PROVIDE 120' OF TEMPORARY CONCRETE MEDIAN BARRIER PER ODOT 622. INCLUDE TERMINAL SECTIONS AT EACH END. INDIVIDUAL SECTIONS SHALL BE PLACED ON FINAL PAVEMENT SURFACE NEAR NEW SOUTH SHEETPILE WALL AS DIRECTED BY THE ENGINEER. EACH SECTION SHALL BE CONNECTED TO THE ADJACENT SECTIONS BY MEANS OF RACEWAY DOWEL BARS OR AS OTHERWISE APPROVED BY THE ENGINEER.
- 6) CONTRACTOR SHALL INSTALL AND MAINTAIN A TEMPORARY ROAD AROUND THE EXISTING PAVEMENT REPLACEMENT AREA UNTIL RESTORATION OF THE FINAL ROADWAY PAVEMENT IS ACCEPTED BY THE ENGINEER. TEMPORARY ROADWAY SHALL BE FORTY (40) FEET WIDE AND CONSIST OF TWELVE (12) INCHES OF ODOT ITEM 304. CONTRACTOR SHALL MAINTAIN DUST CONTROL REQUIREMENTS OF ODOT SPECIFICATION 616.

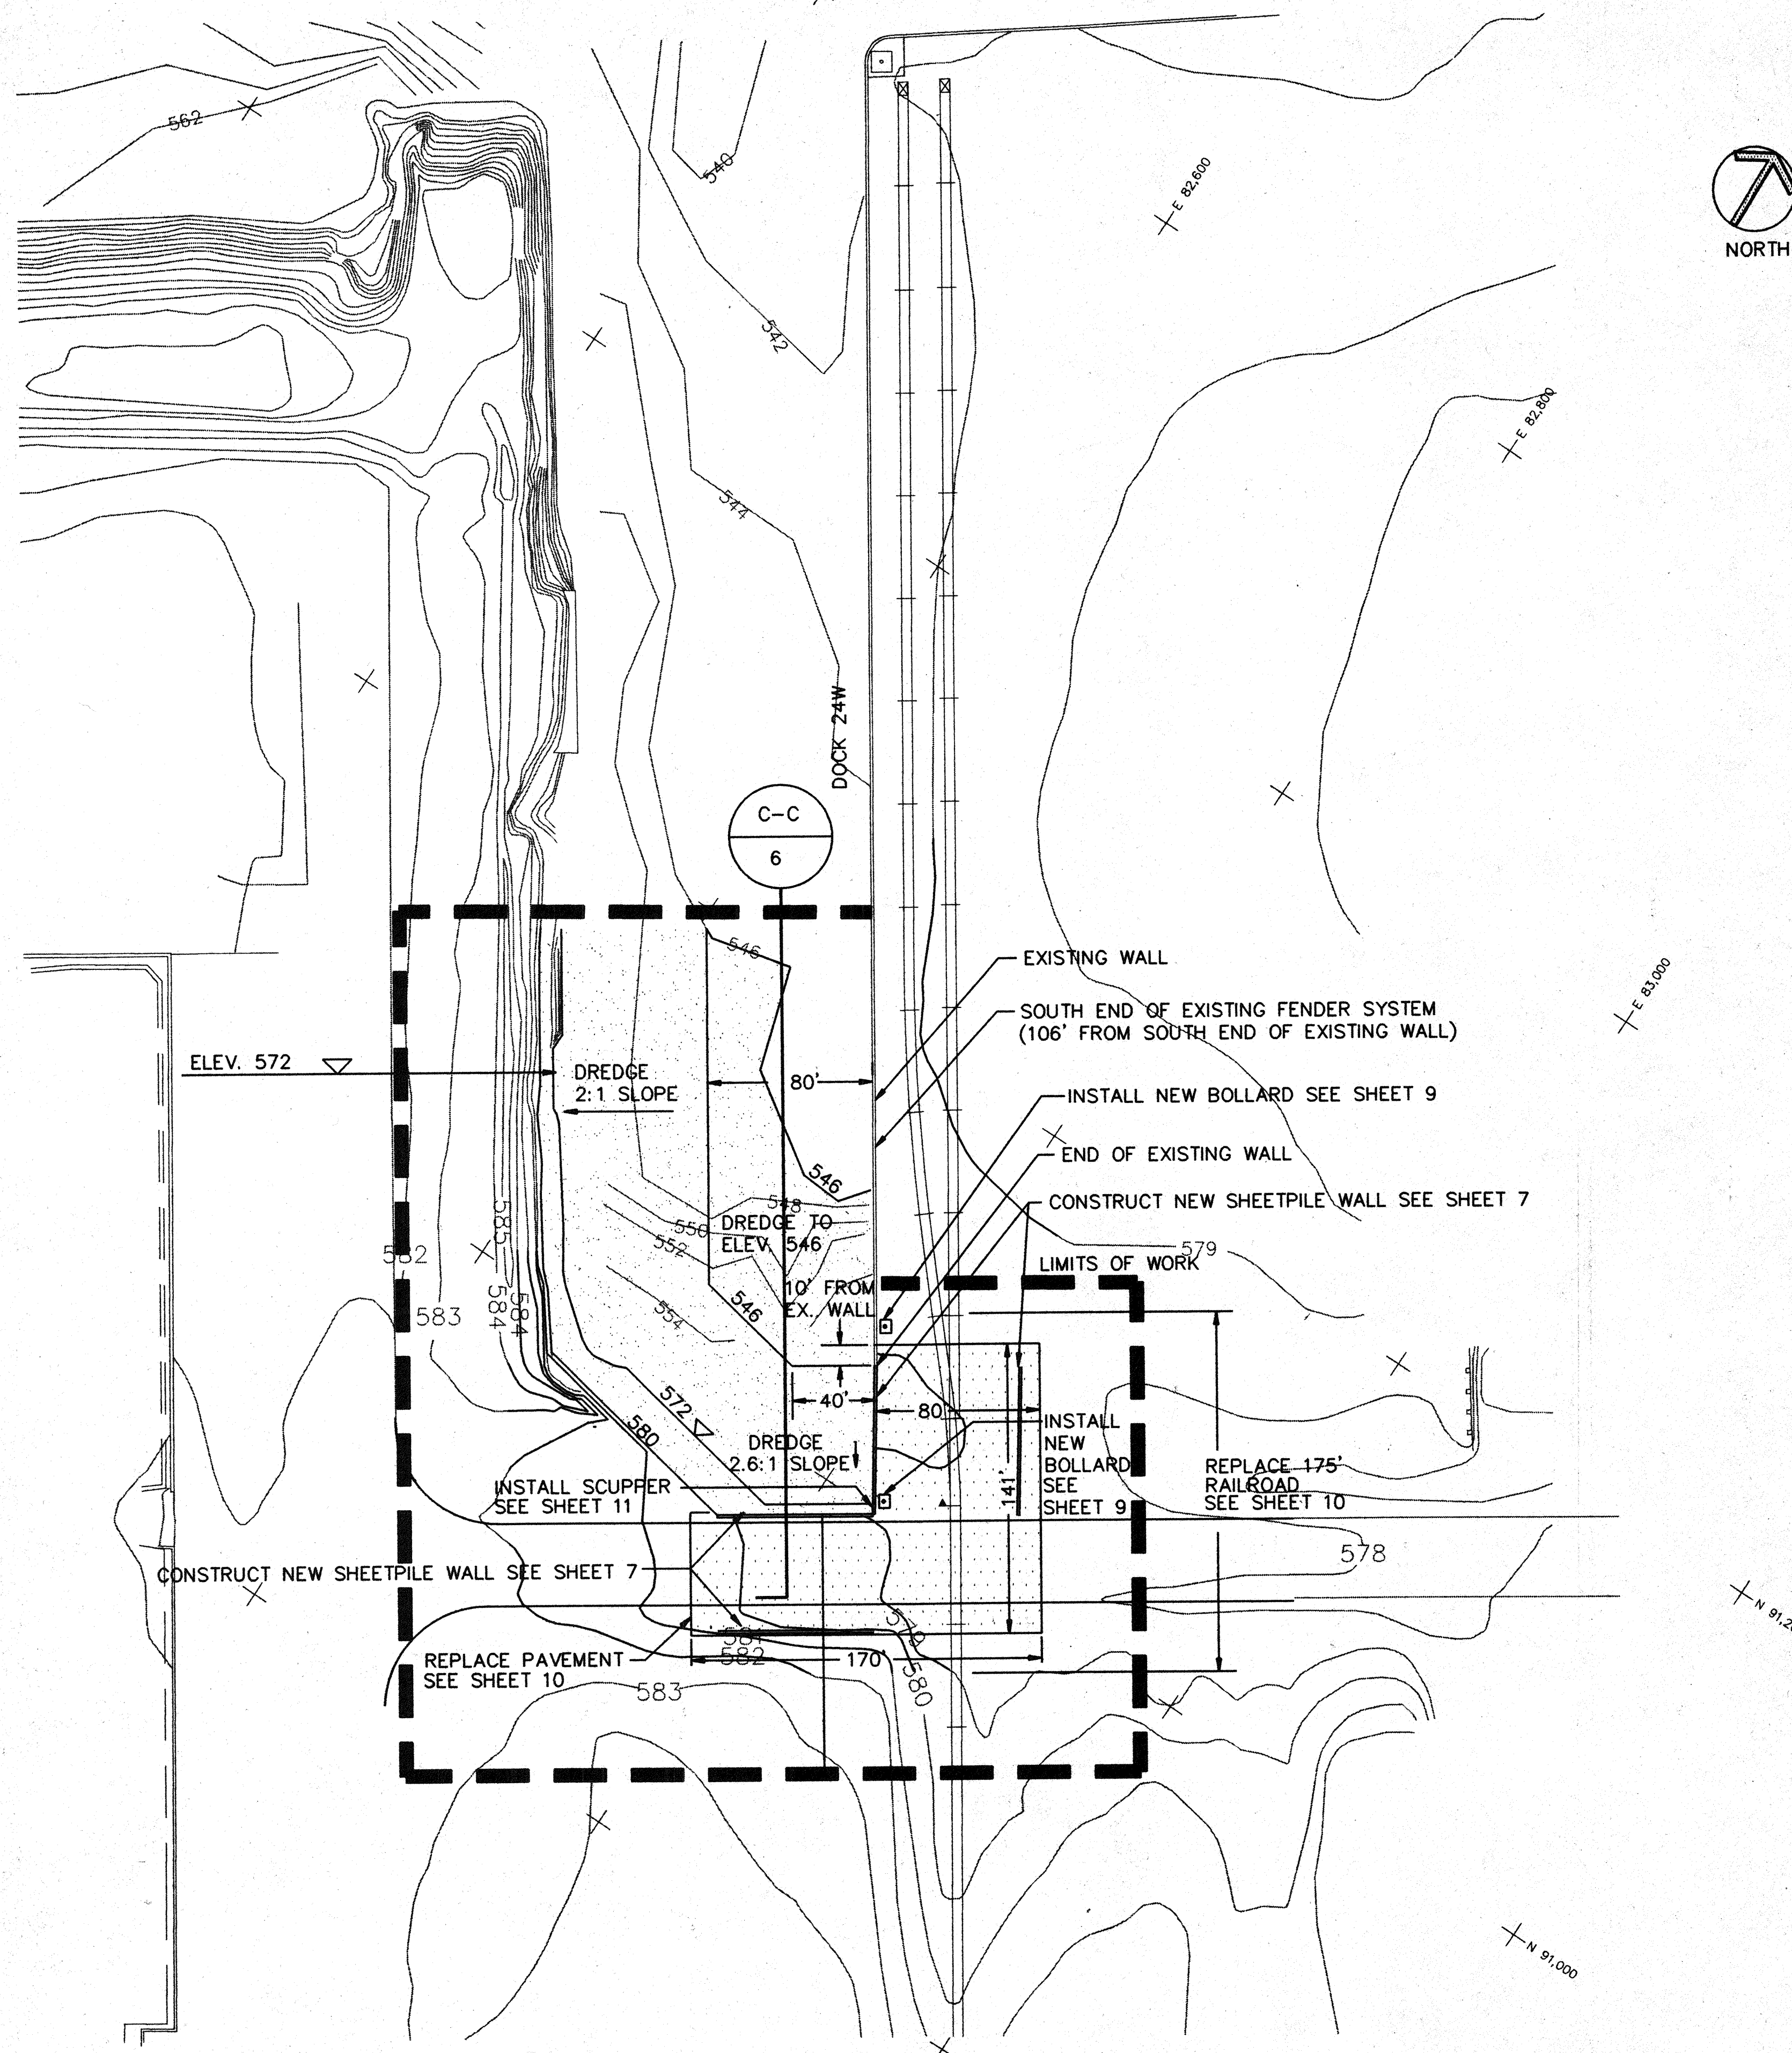

No.	Date	By	Revision
2	3/4/92	PGP	APPROVED FOR CONSTRUCTION
1	1/13/92	PGP	BID ISSUE ONLY









Turner  
URS CONSULTANTS  
POLYTECH

DESIGNED BY: PGP	DATE: 5/15/91
DRAWN BY: PGP	DATE: 5/21/91
CHECKED BY: DSP	DATE: 7/17/91
SCALE 1" = 50'	

DOCK 24W SLIP EXTENSION  
CLEVELAND-CUYAHOGA COUNTY  
PORT AUTHORITY

ANTHONY F. FUGARO, EXEC. DIRECTOR  
JAY C. EHLE, CHAIRMAN OF THE BOARD

CONSTRUCTION PLAN

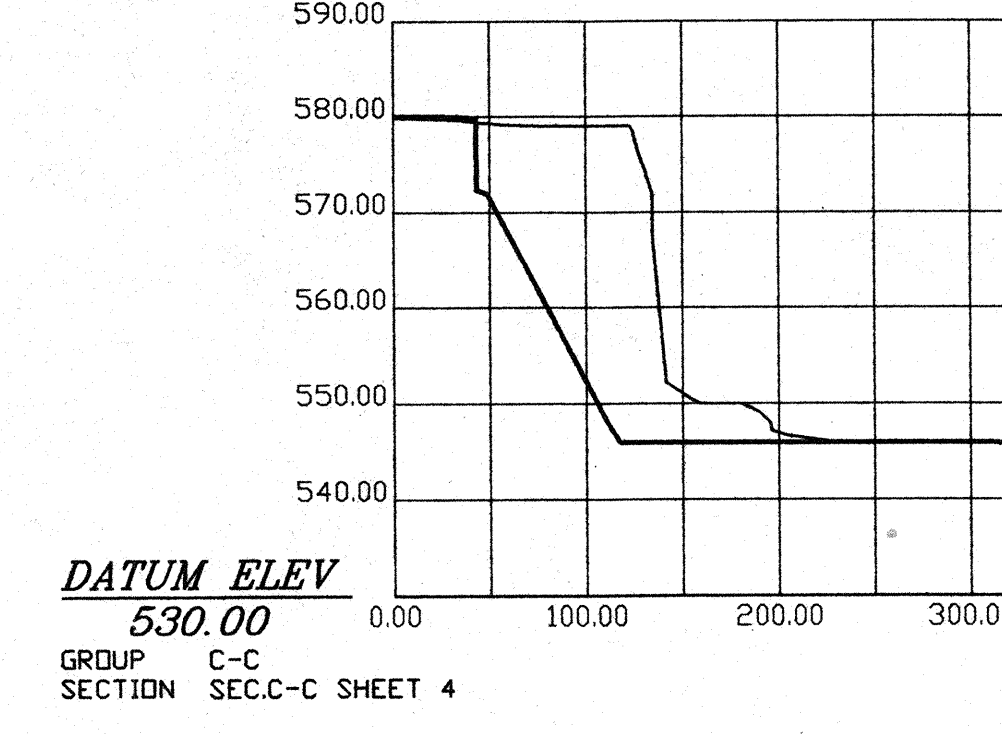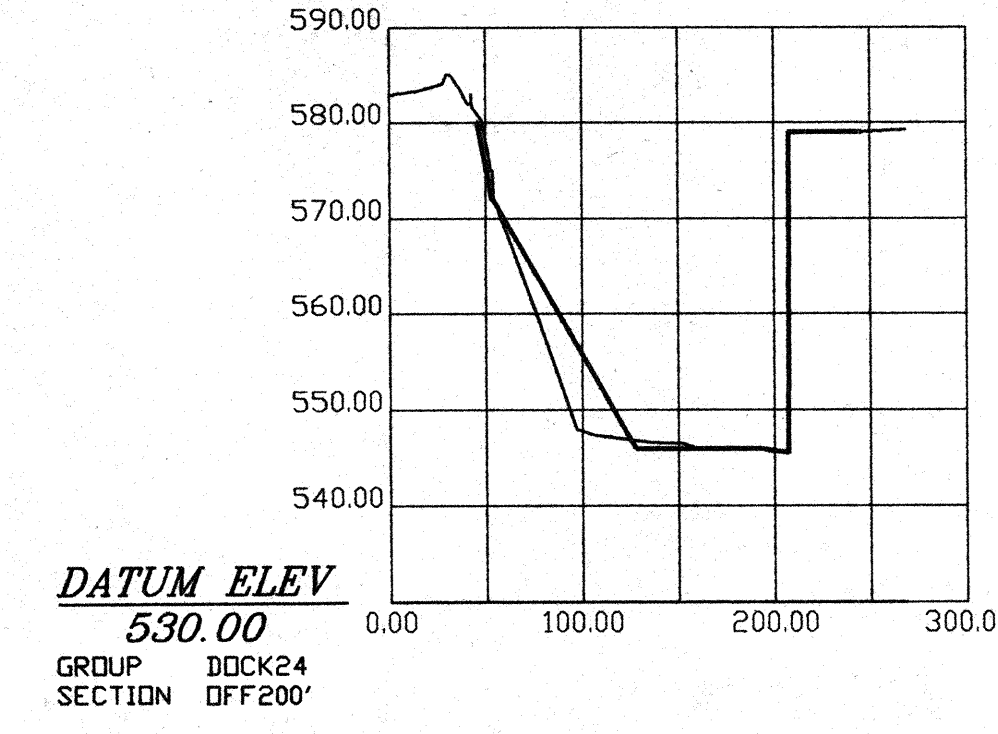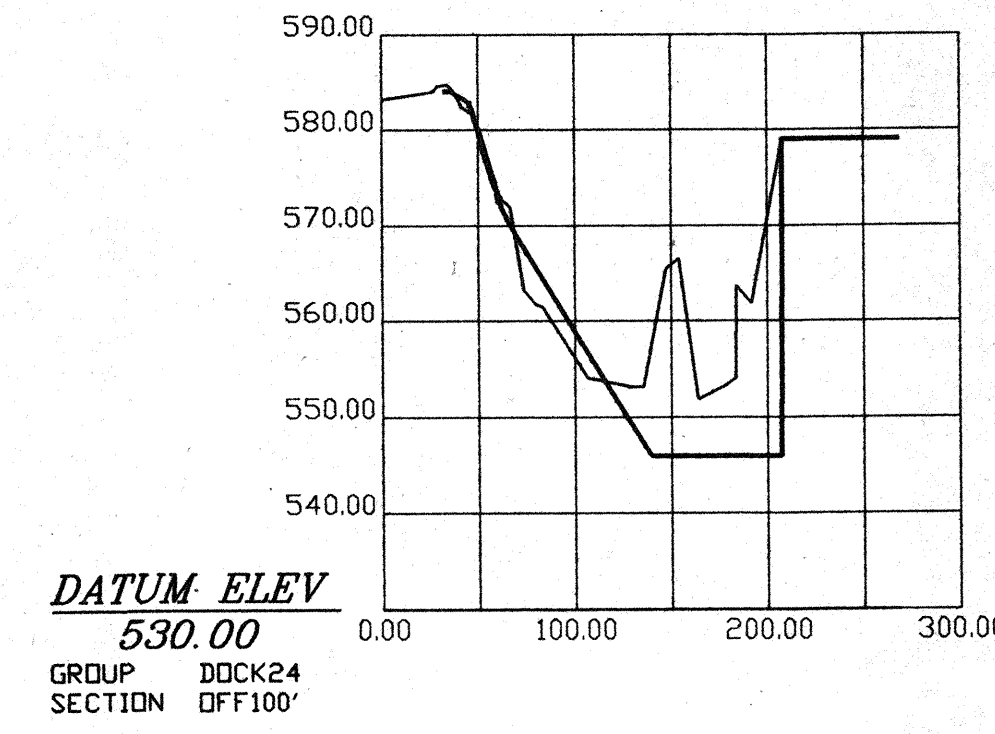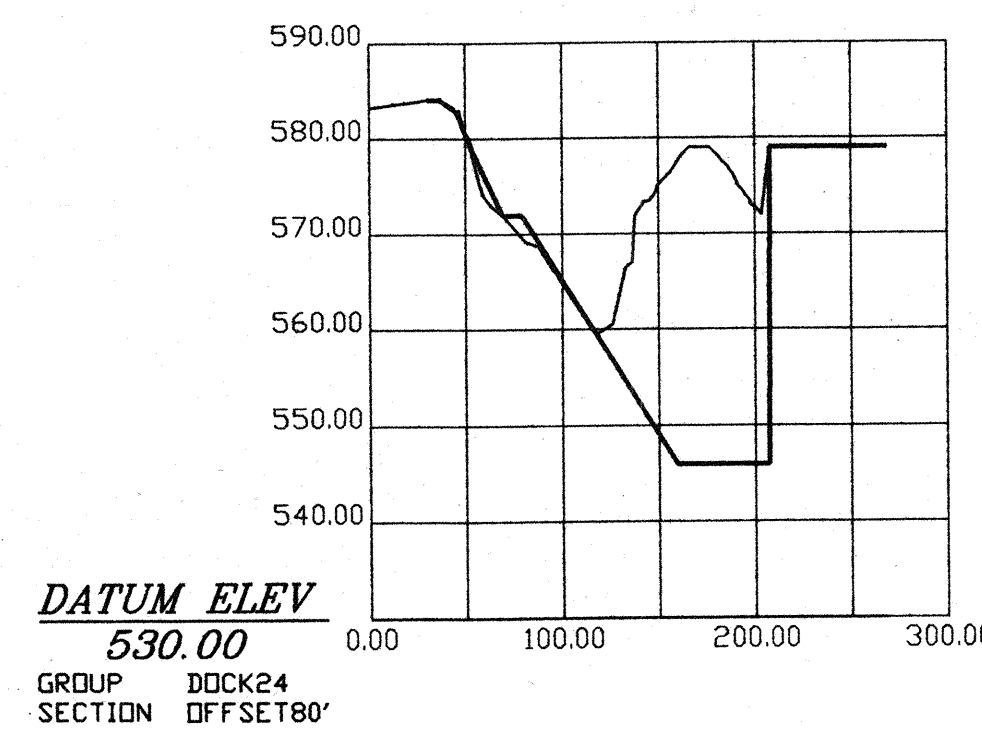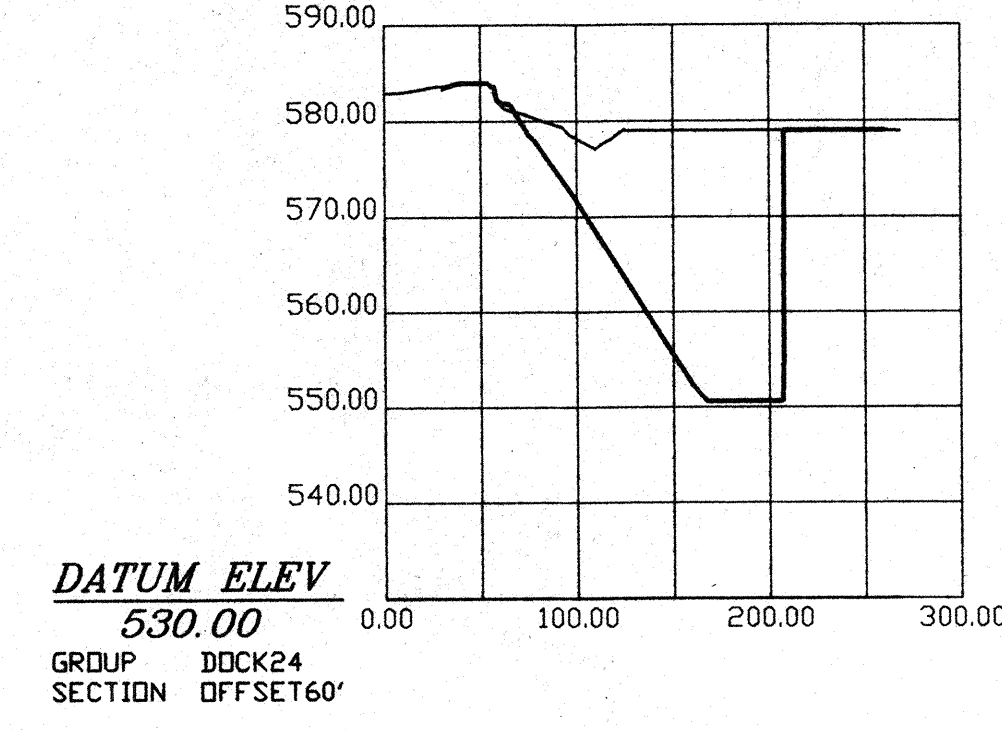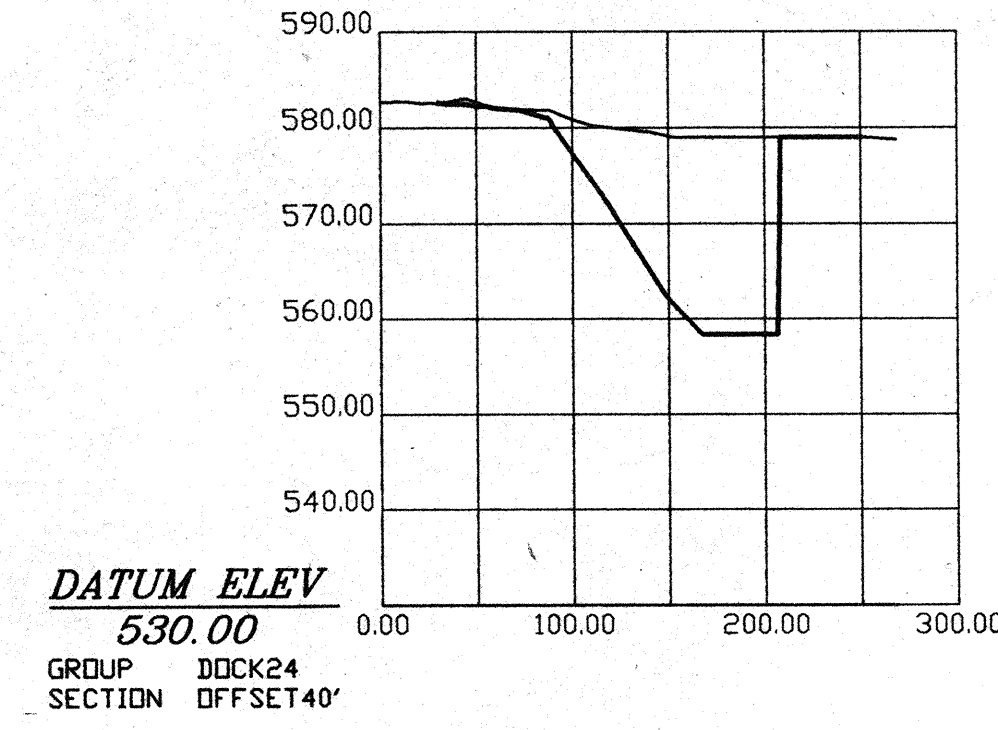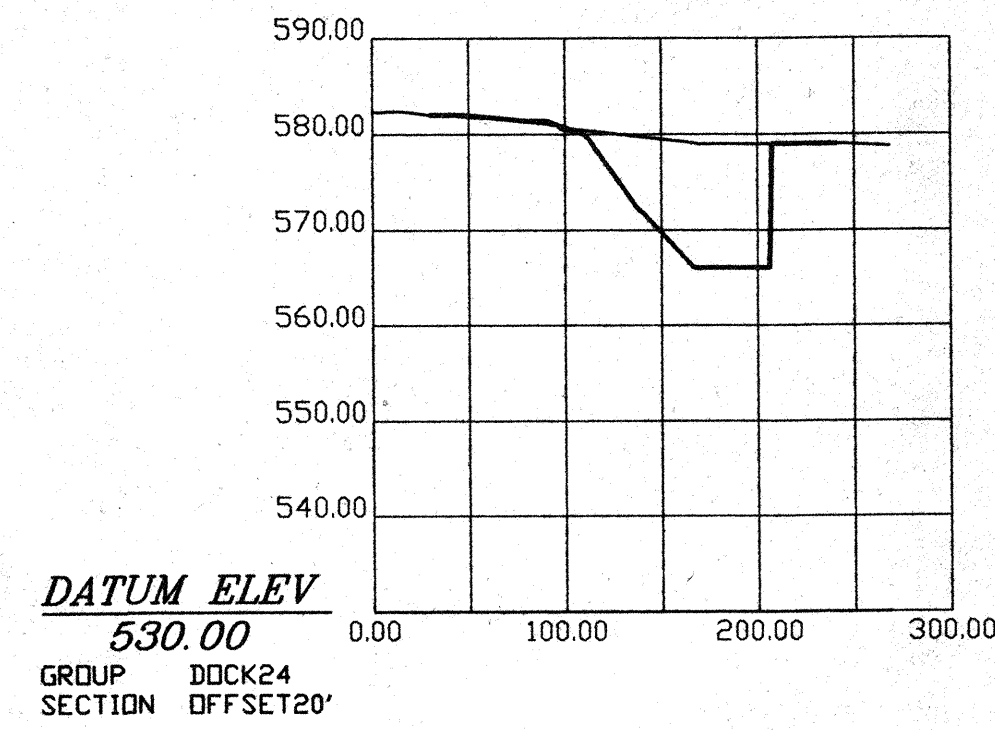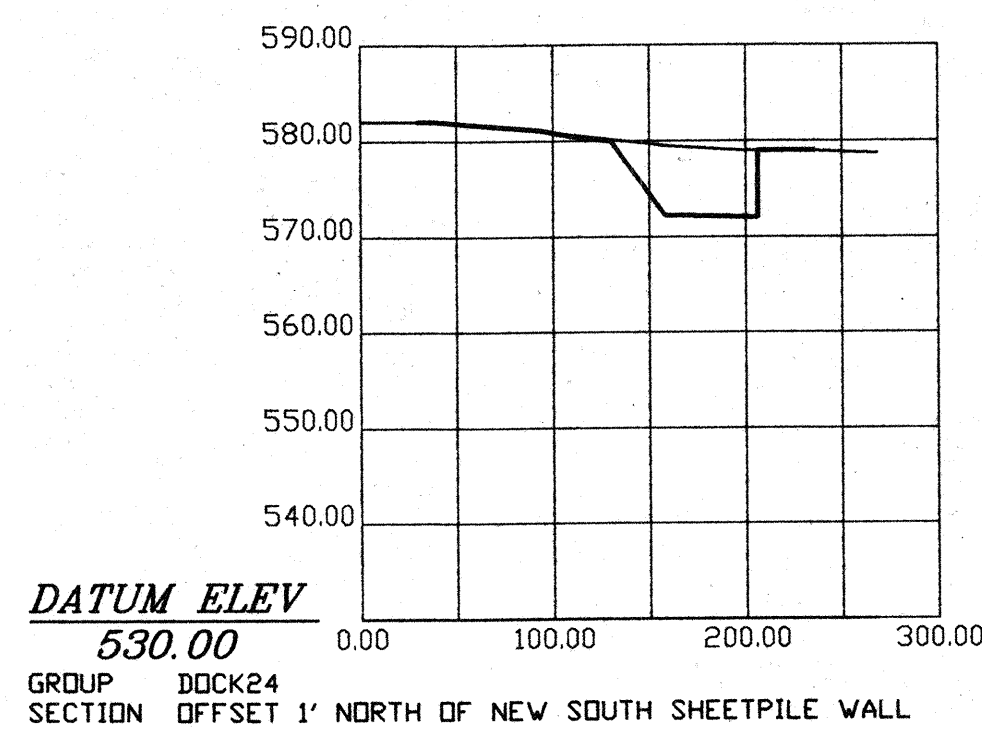

**LEGEND**

EXISTING GROUND ELEVATION \_\_\_\_\_  
PROPOSED GROUND ELEVATION \_\_\_\_\_

No.	Date	By	Revision
2	3/4/92	PGP	APPROVED FOR CONSTRUCTION
1	1/13/92	PGP	BID ISSUE ONLY

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URS CONSULTANTS  
POLYTECH

DESIGNED BY: PGP	DATE: 5/19/91
DRAWN BY: PGP	DATE: 5/21/91
CHECKED BY: DSP	DATE: 5/21/91
SCALE 1" = 100'	







DOCK 24W SLIP EXTENSION  
CLEVELAND-CUYAHOGA COUNTY  
PORT AUTHORITY

ANTHONY F. FUGARD, EXEC. DIRECTOR  
JAY C. EHLE, CHAIRMAN OF THE BOARD

DREDGE SECTIONS

PROJECT NO. 8921300

NOTE: IF NECESSARY, PULL LAST PILE AND CUT EXISTING WALER TO PROVIDE A STRAIGHT FACING WITH NEW SHEETS.

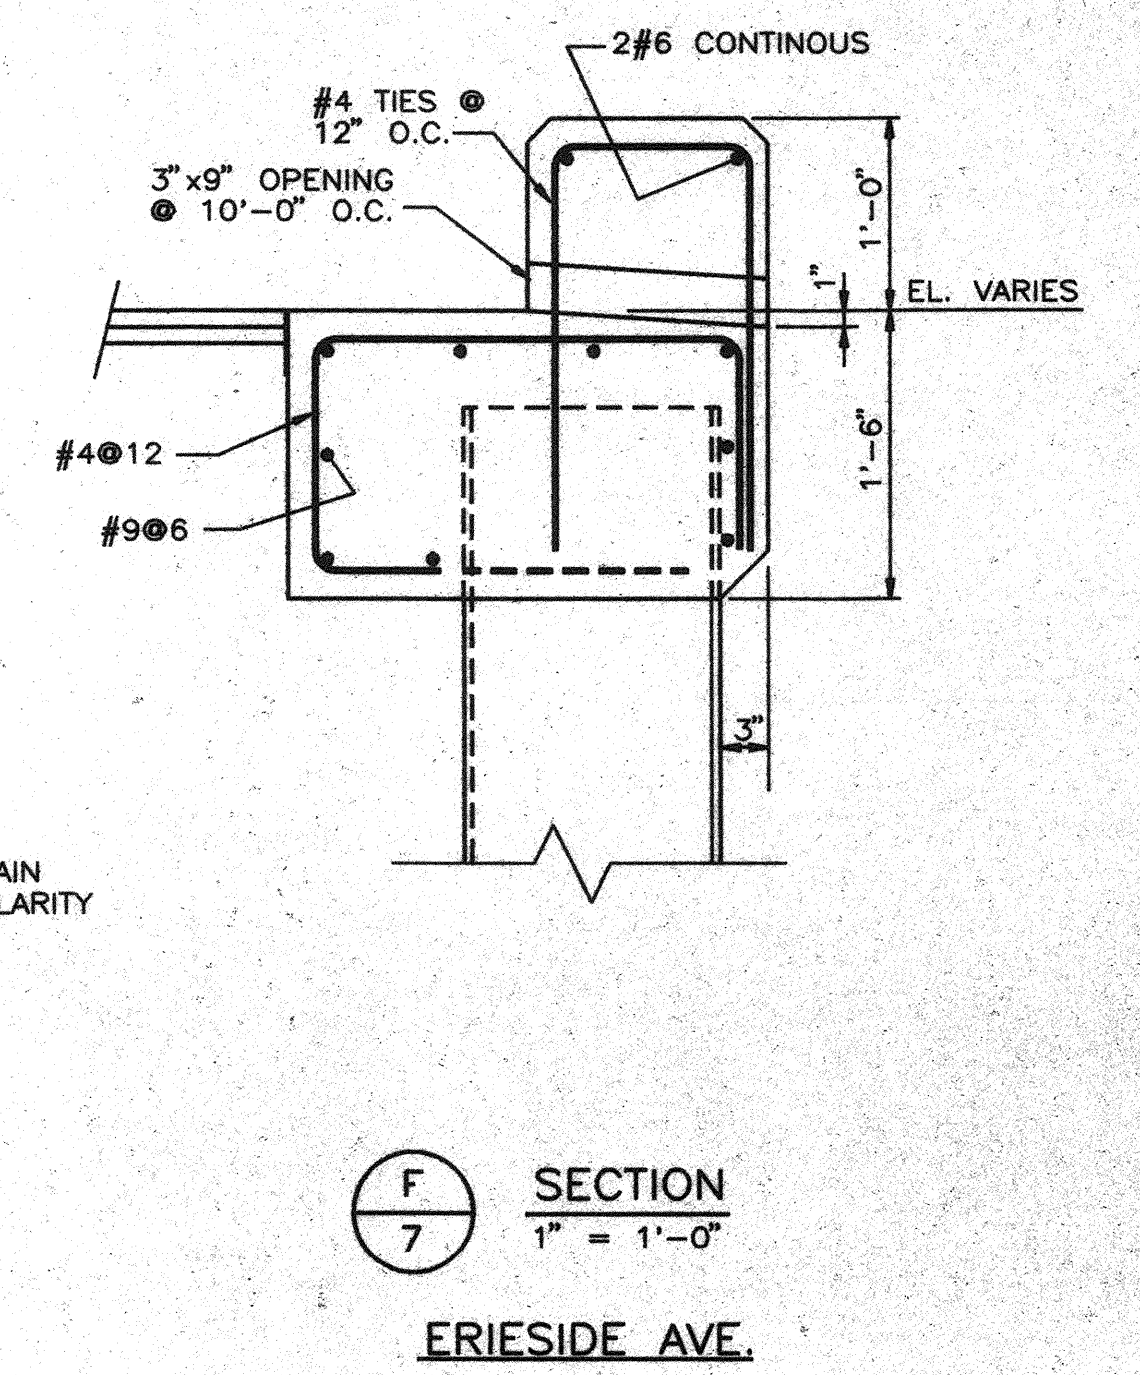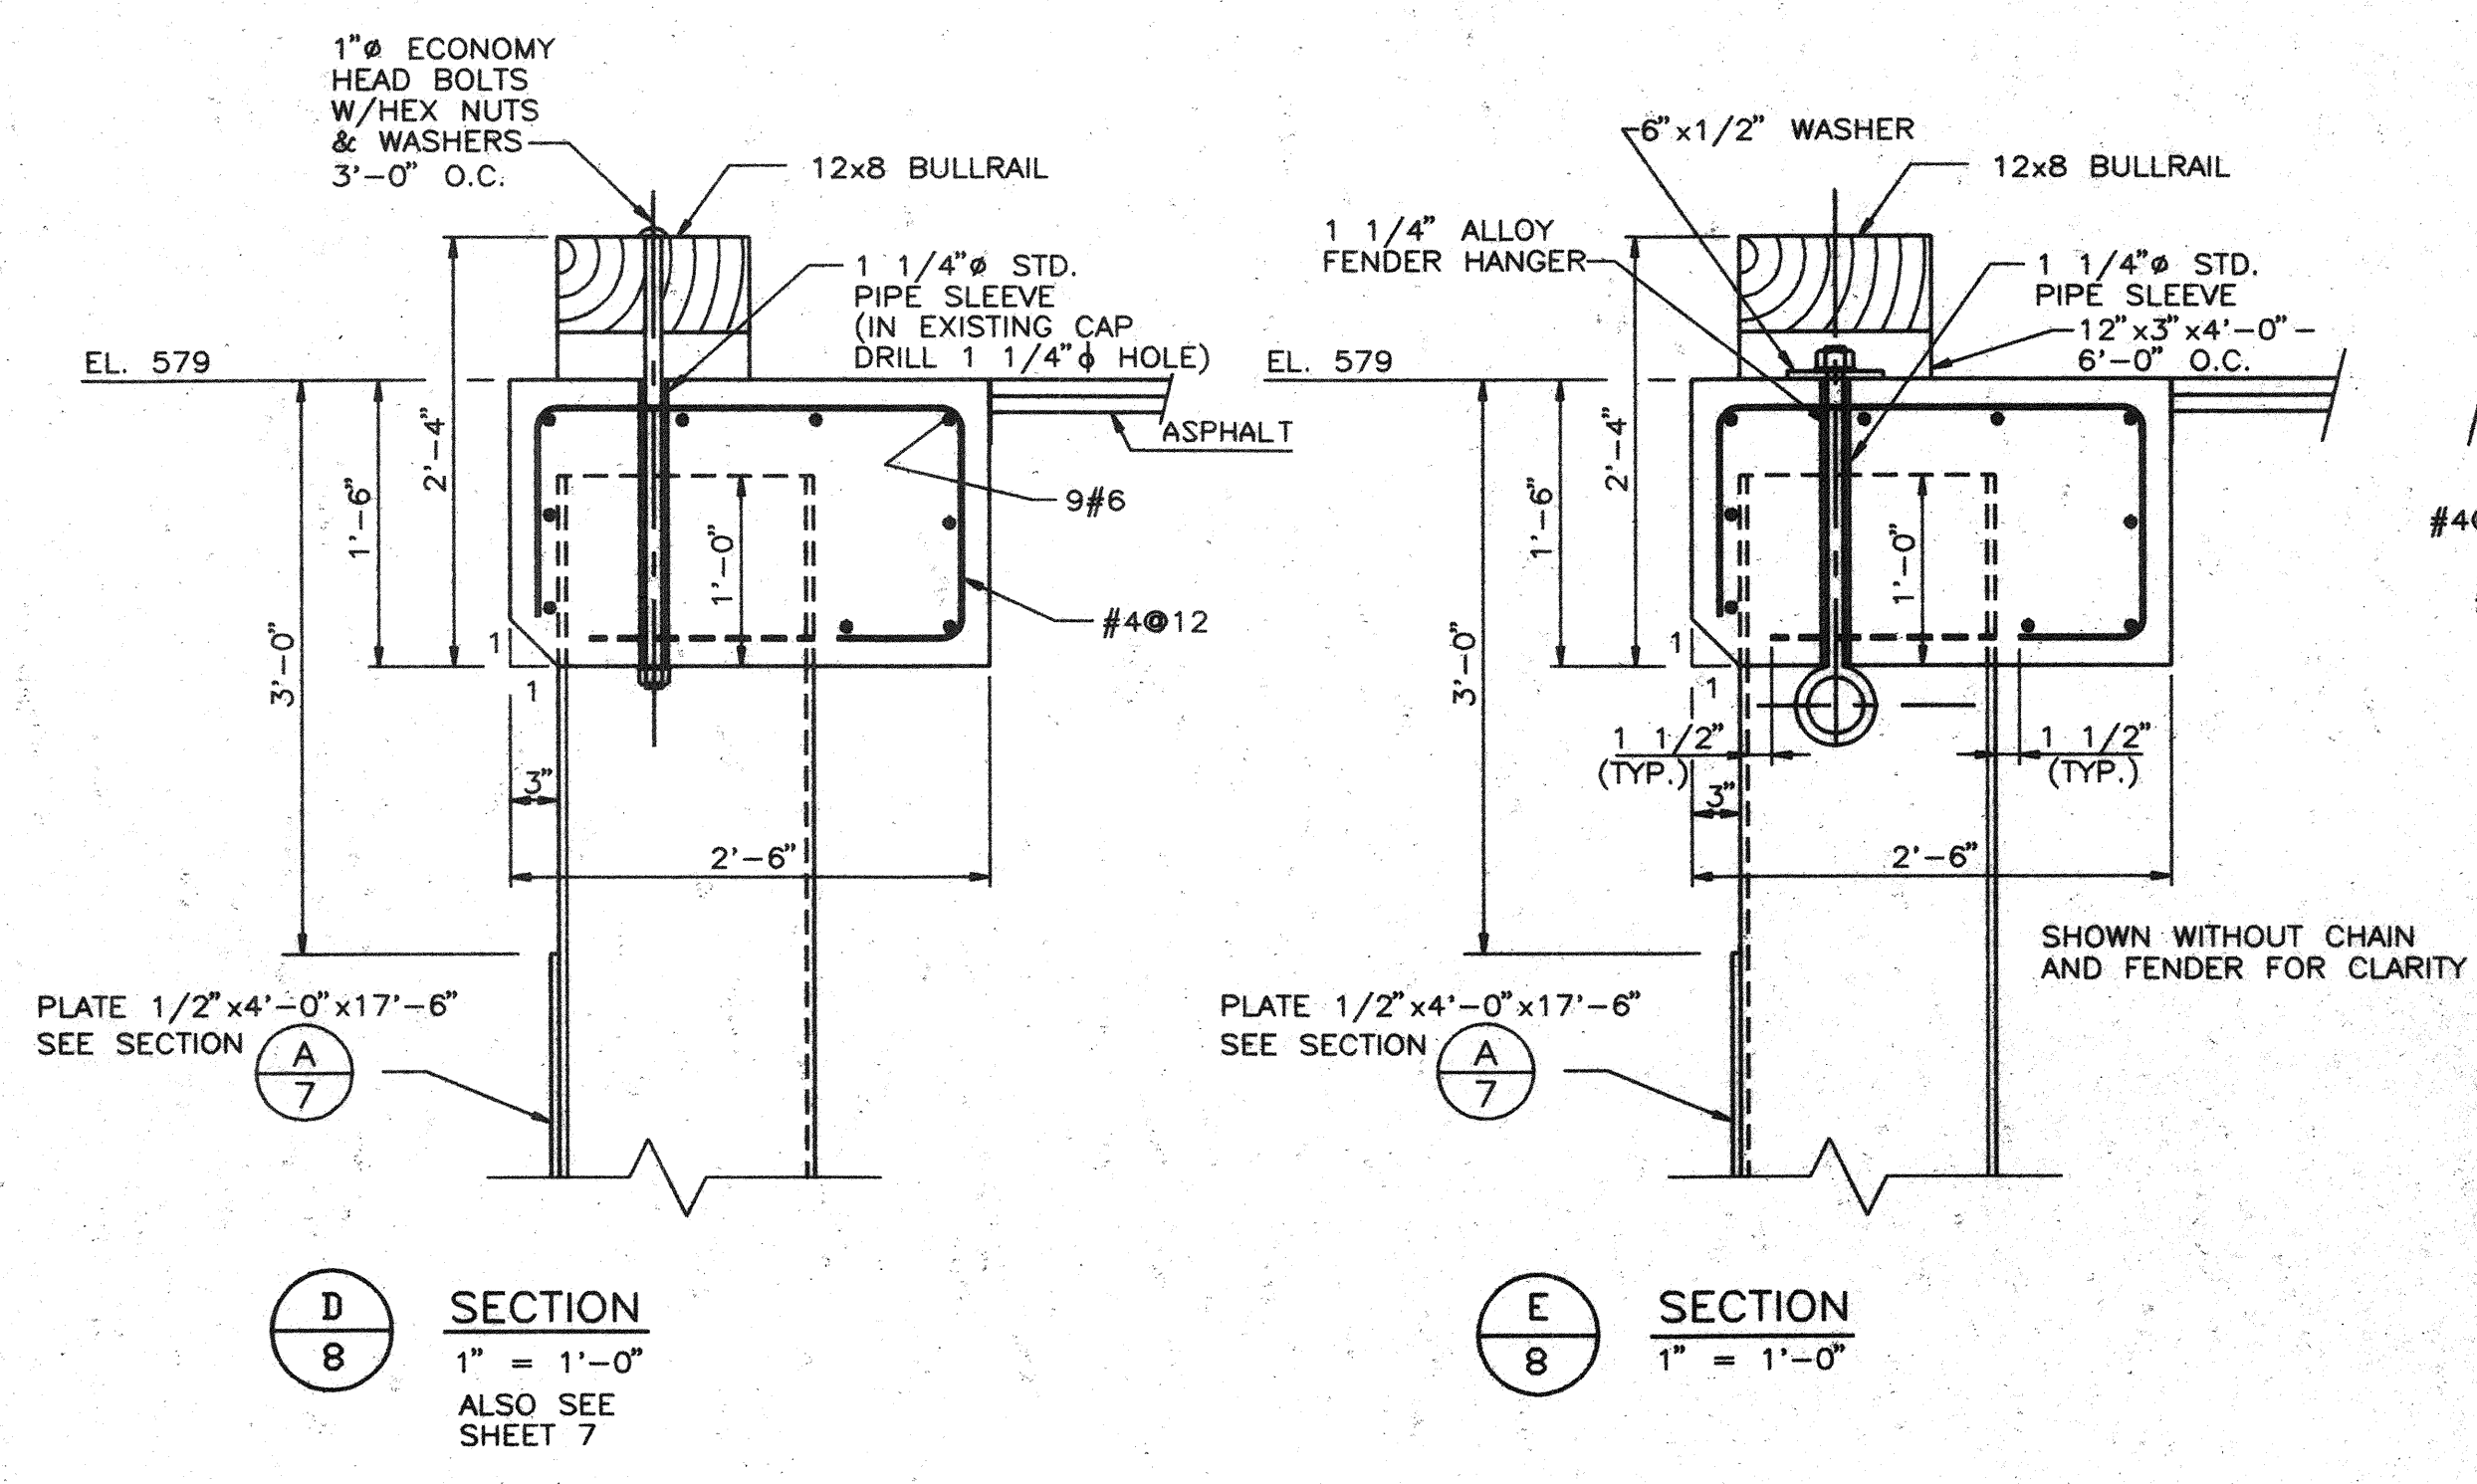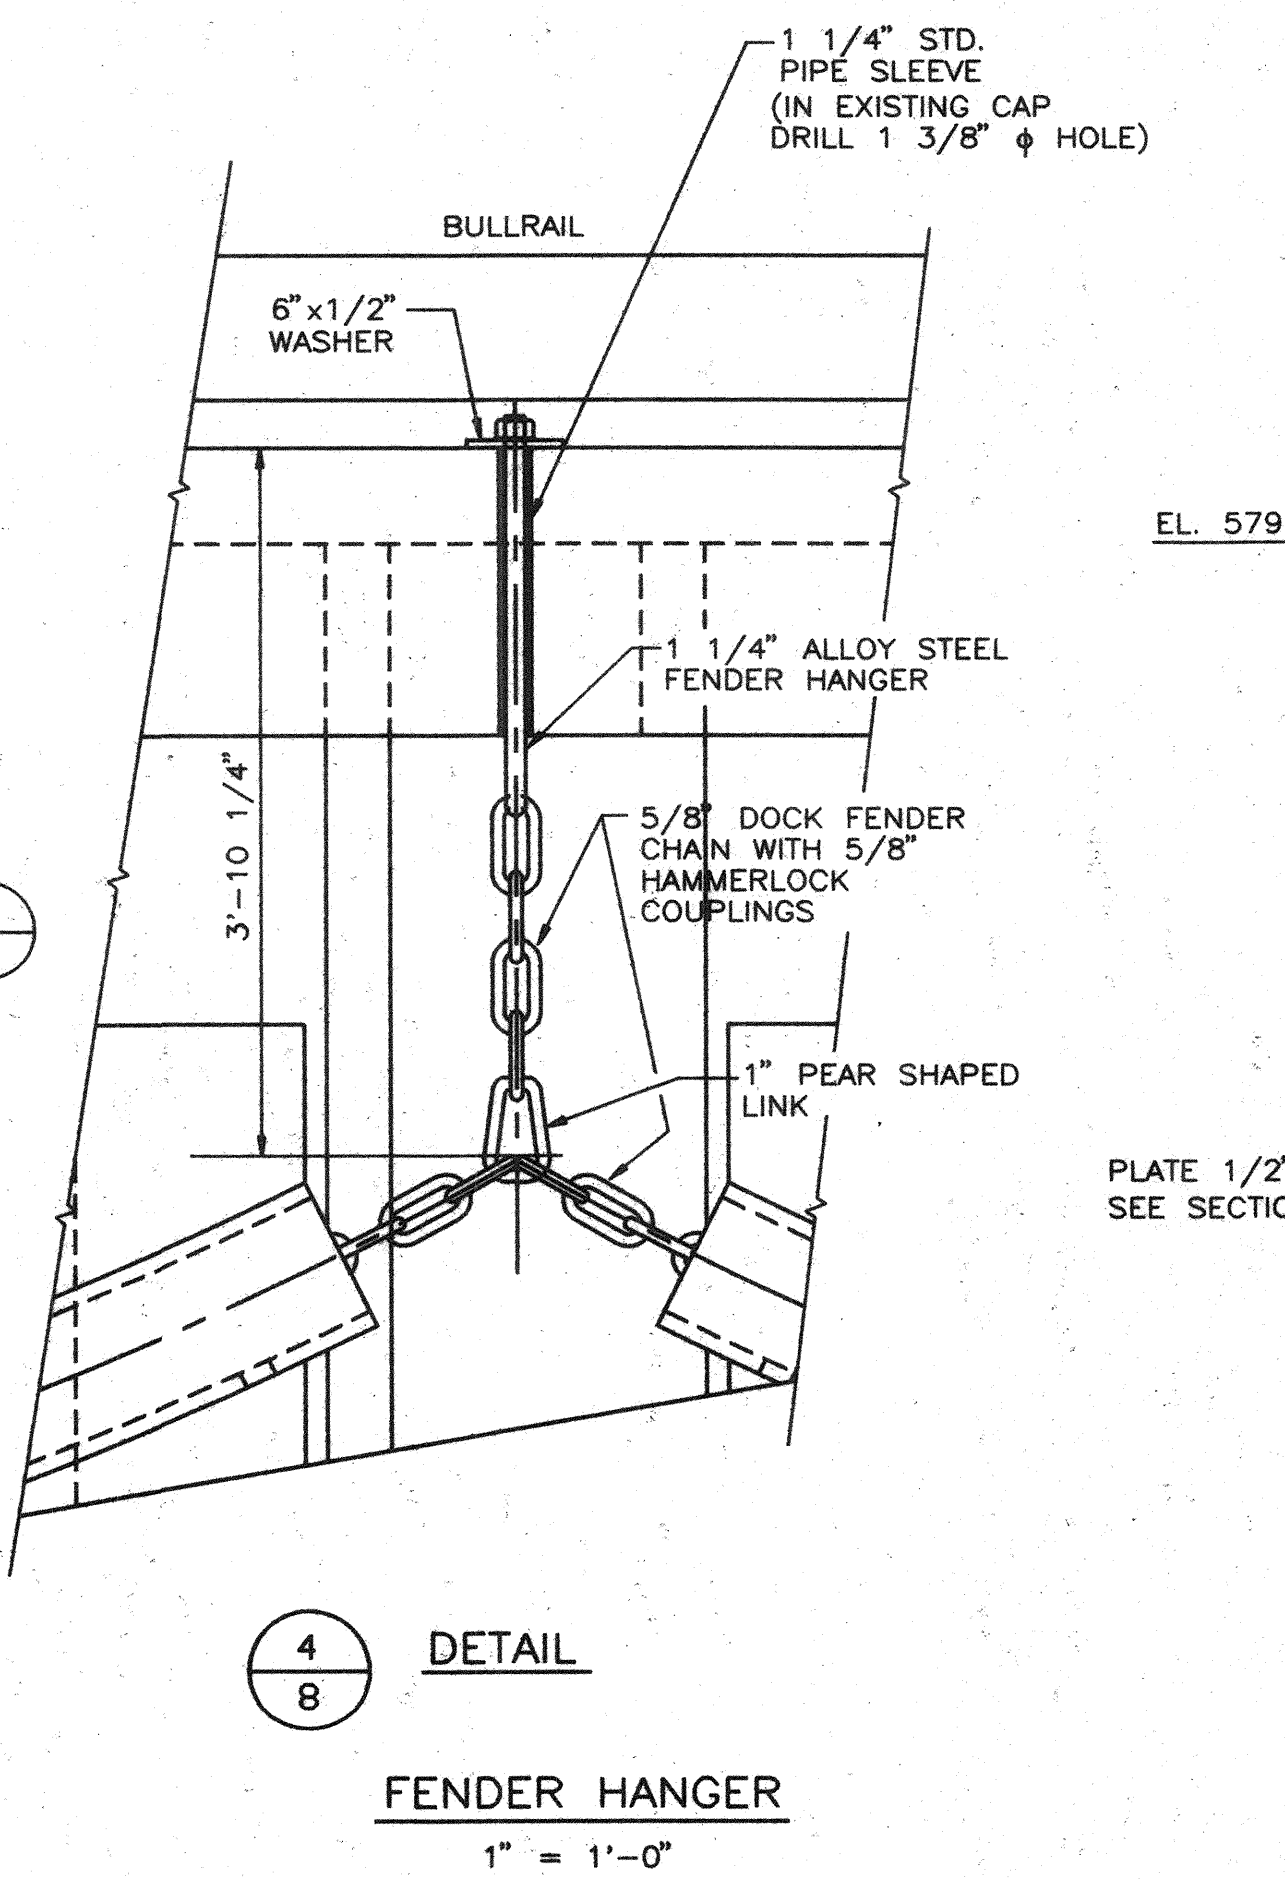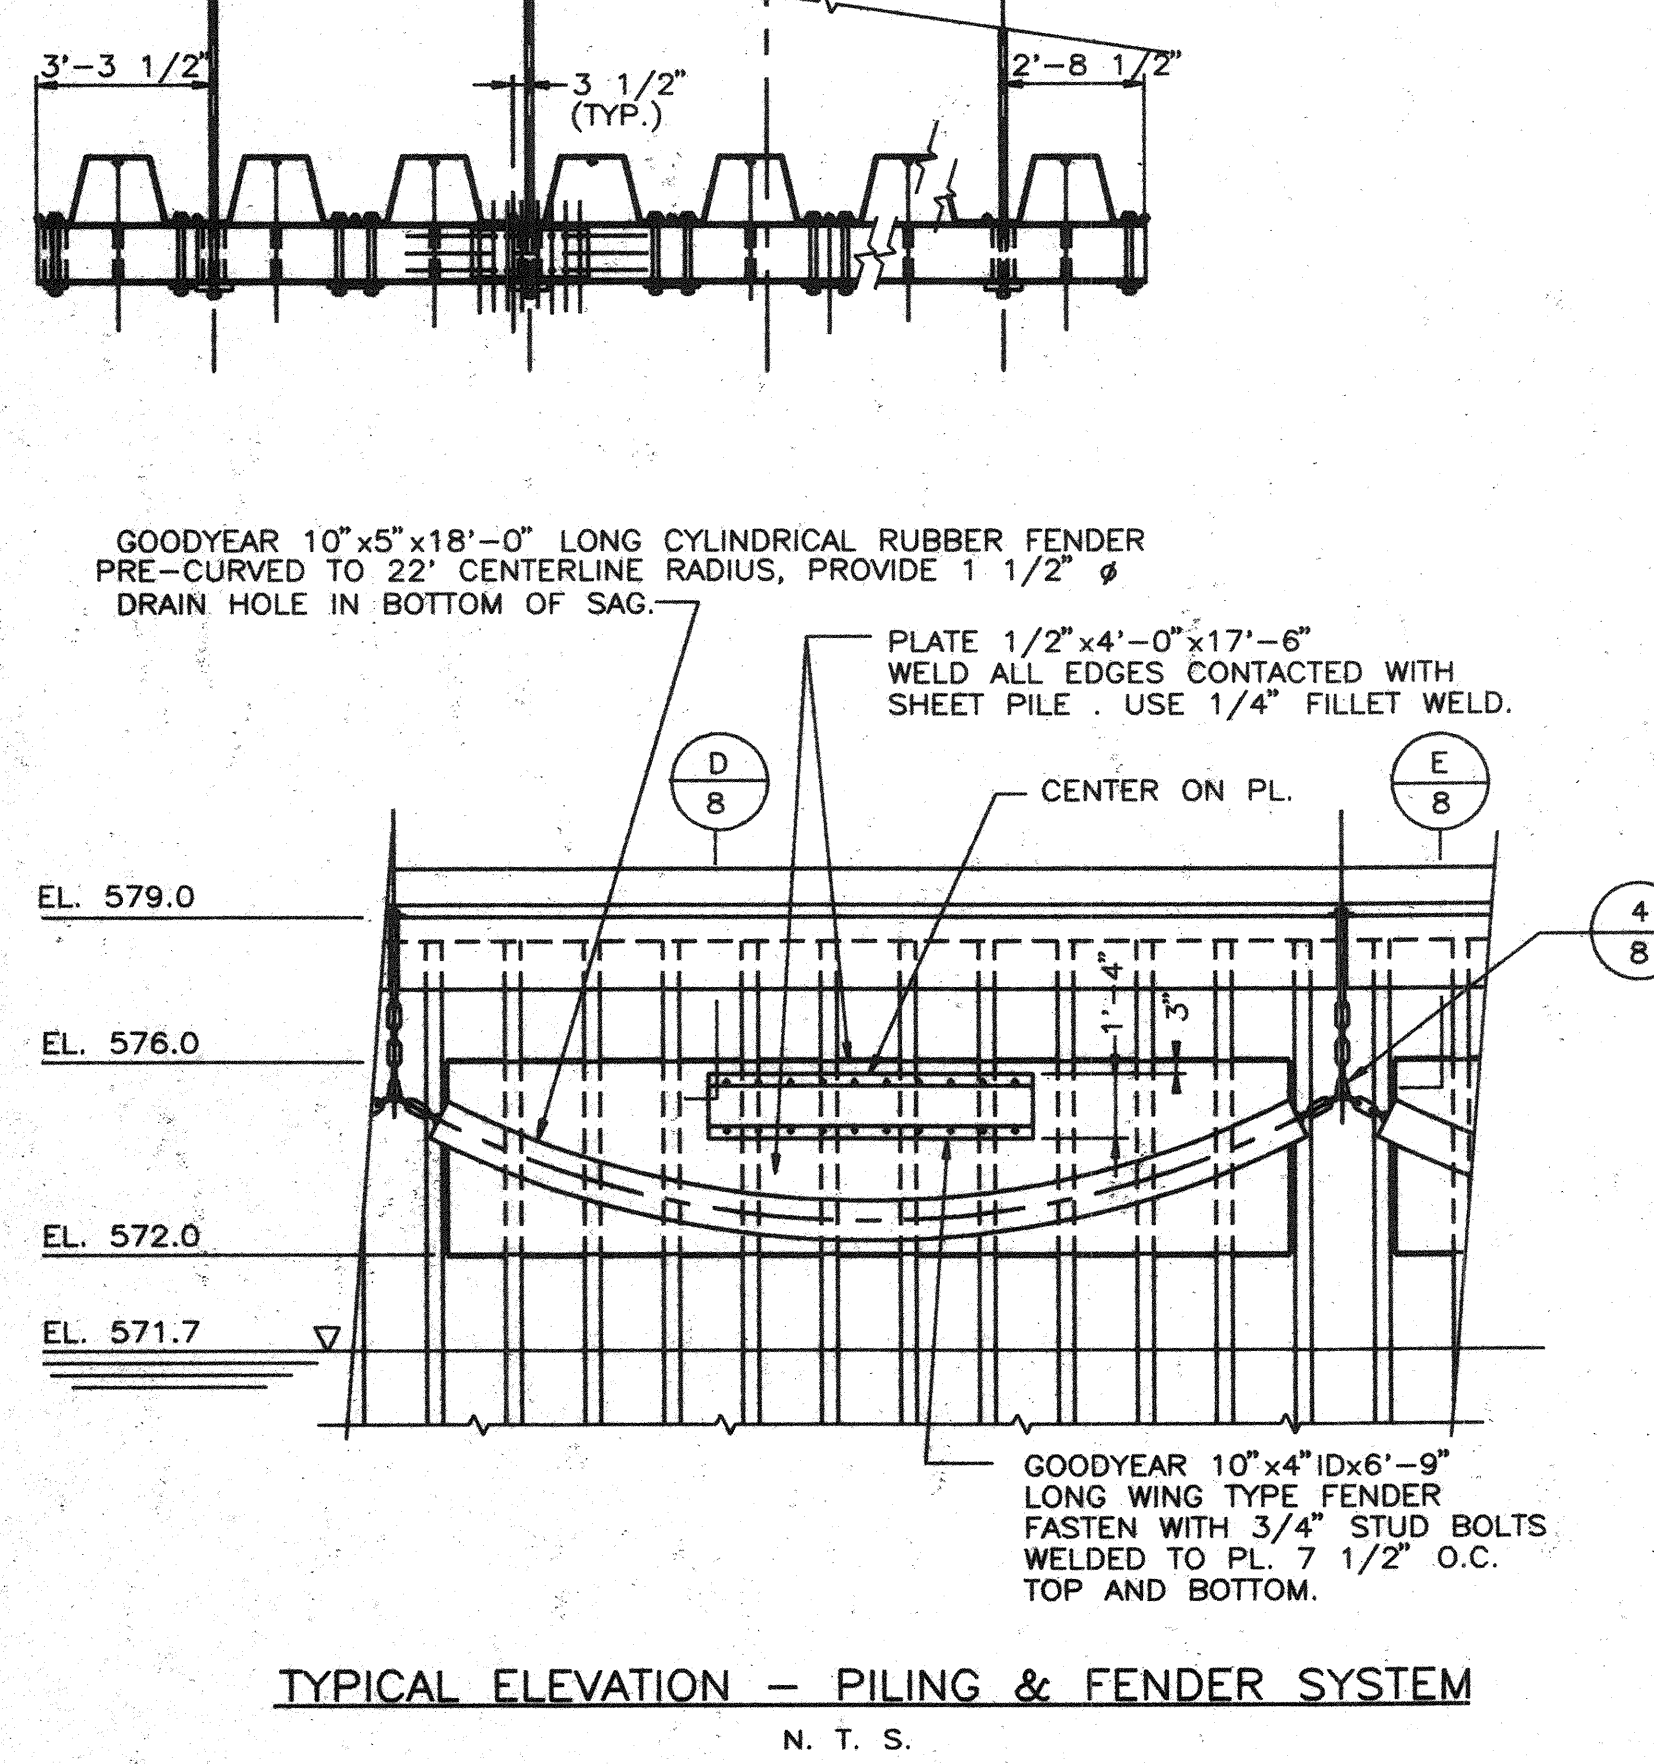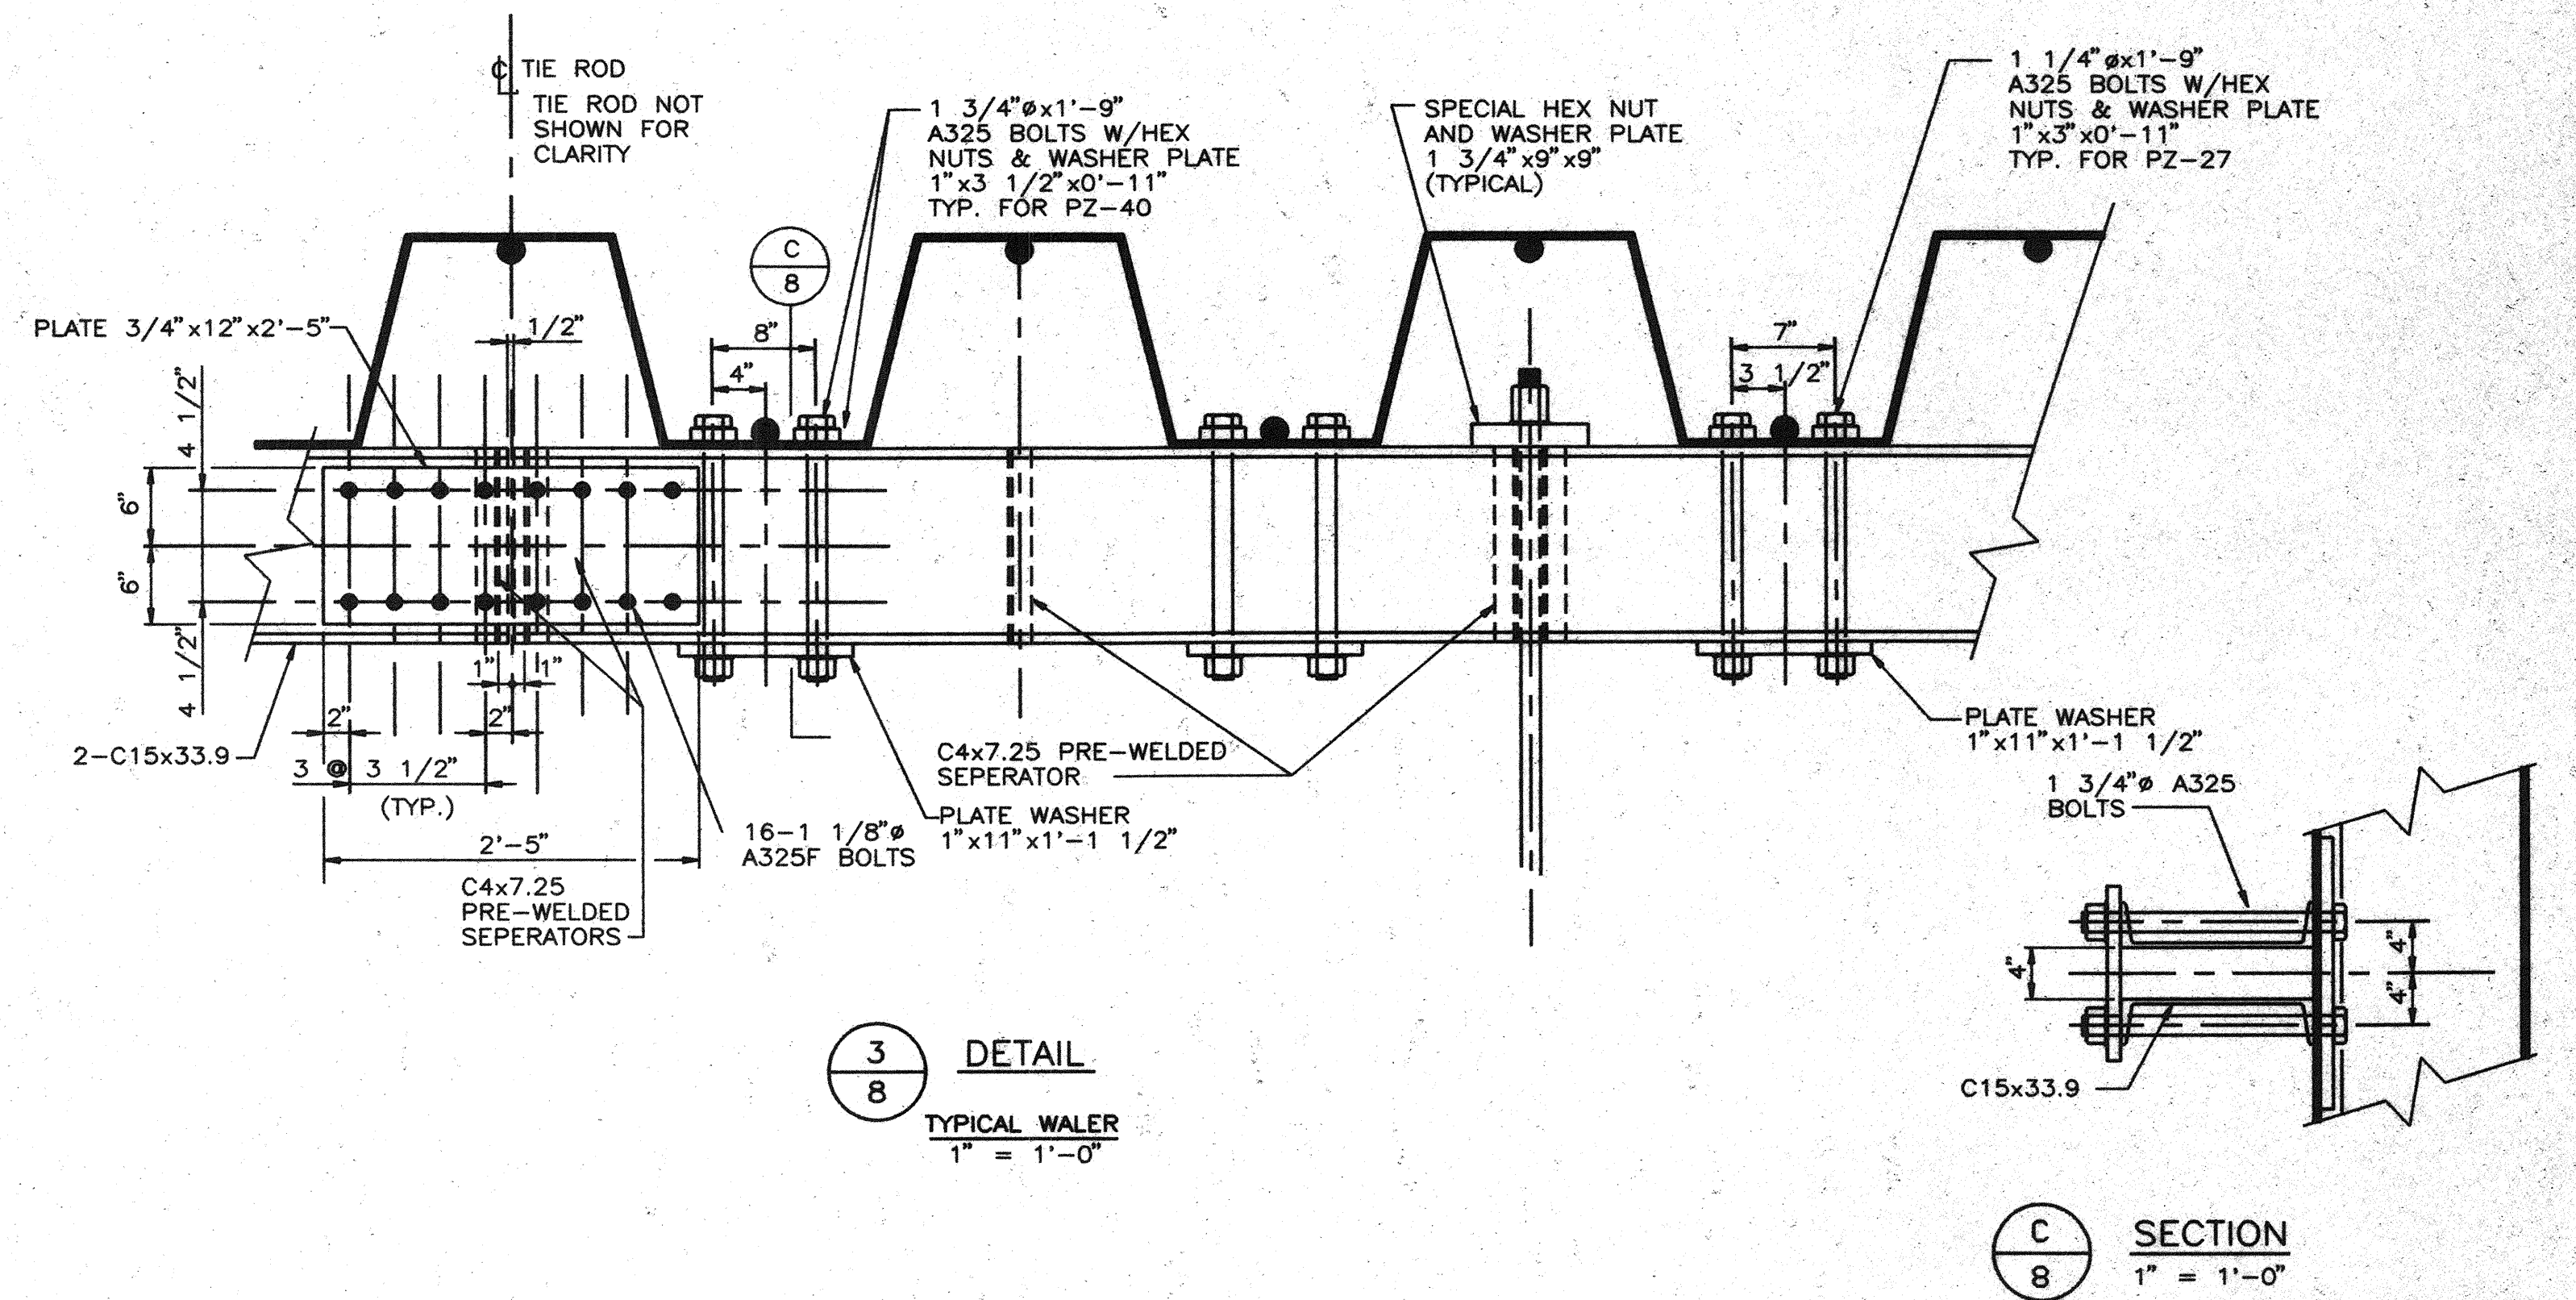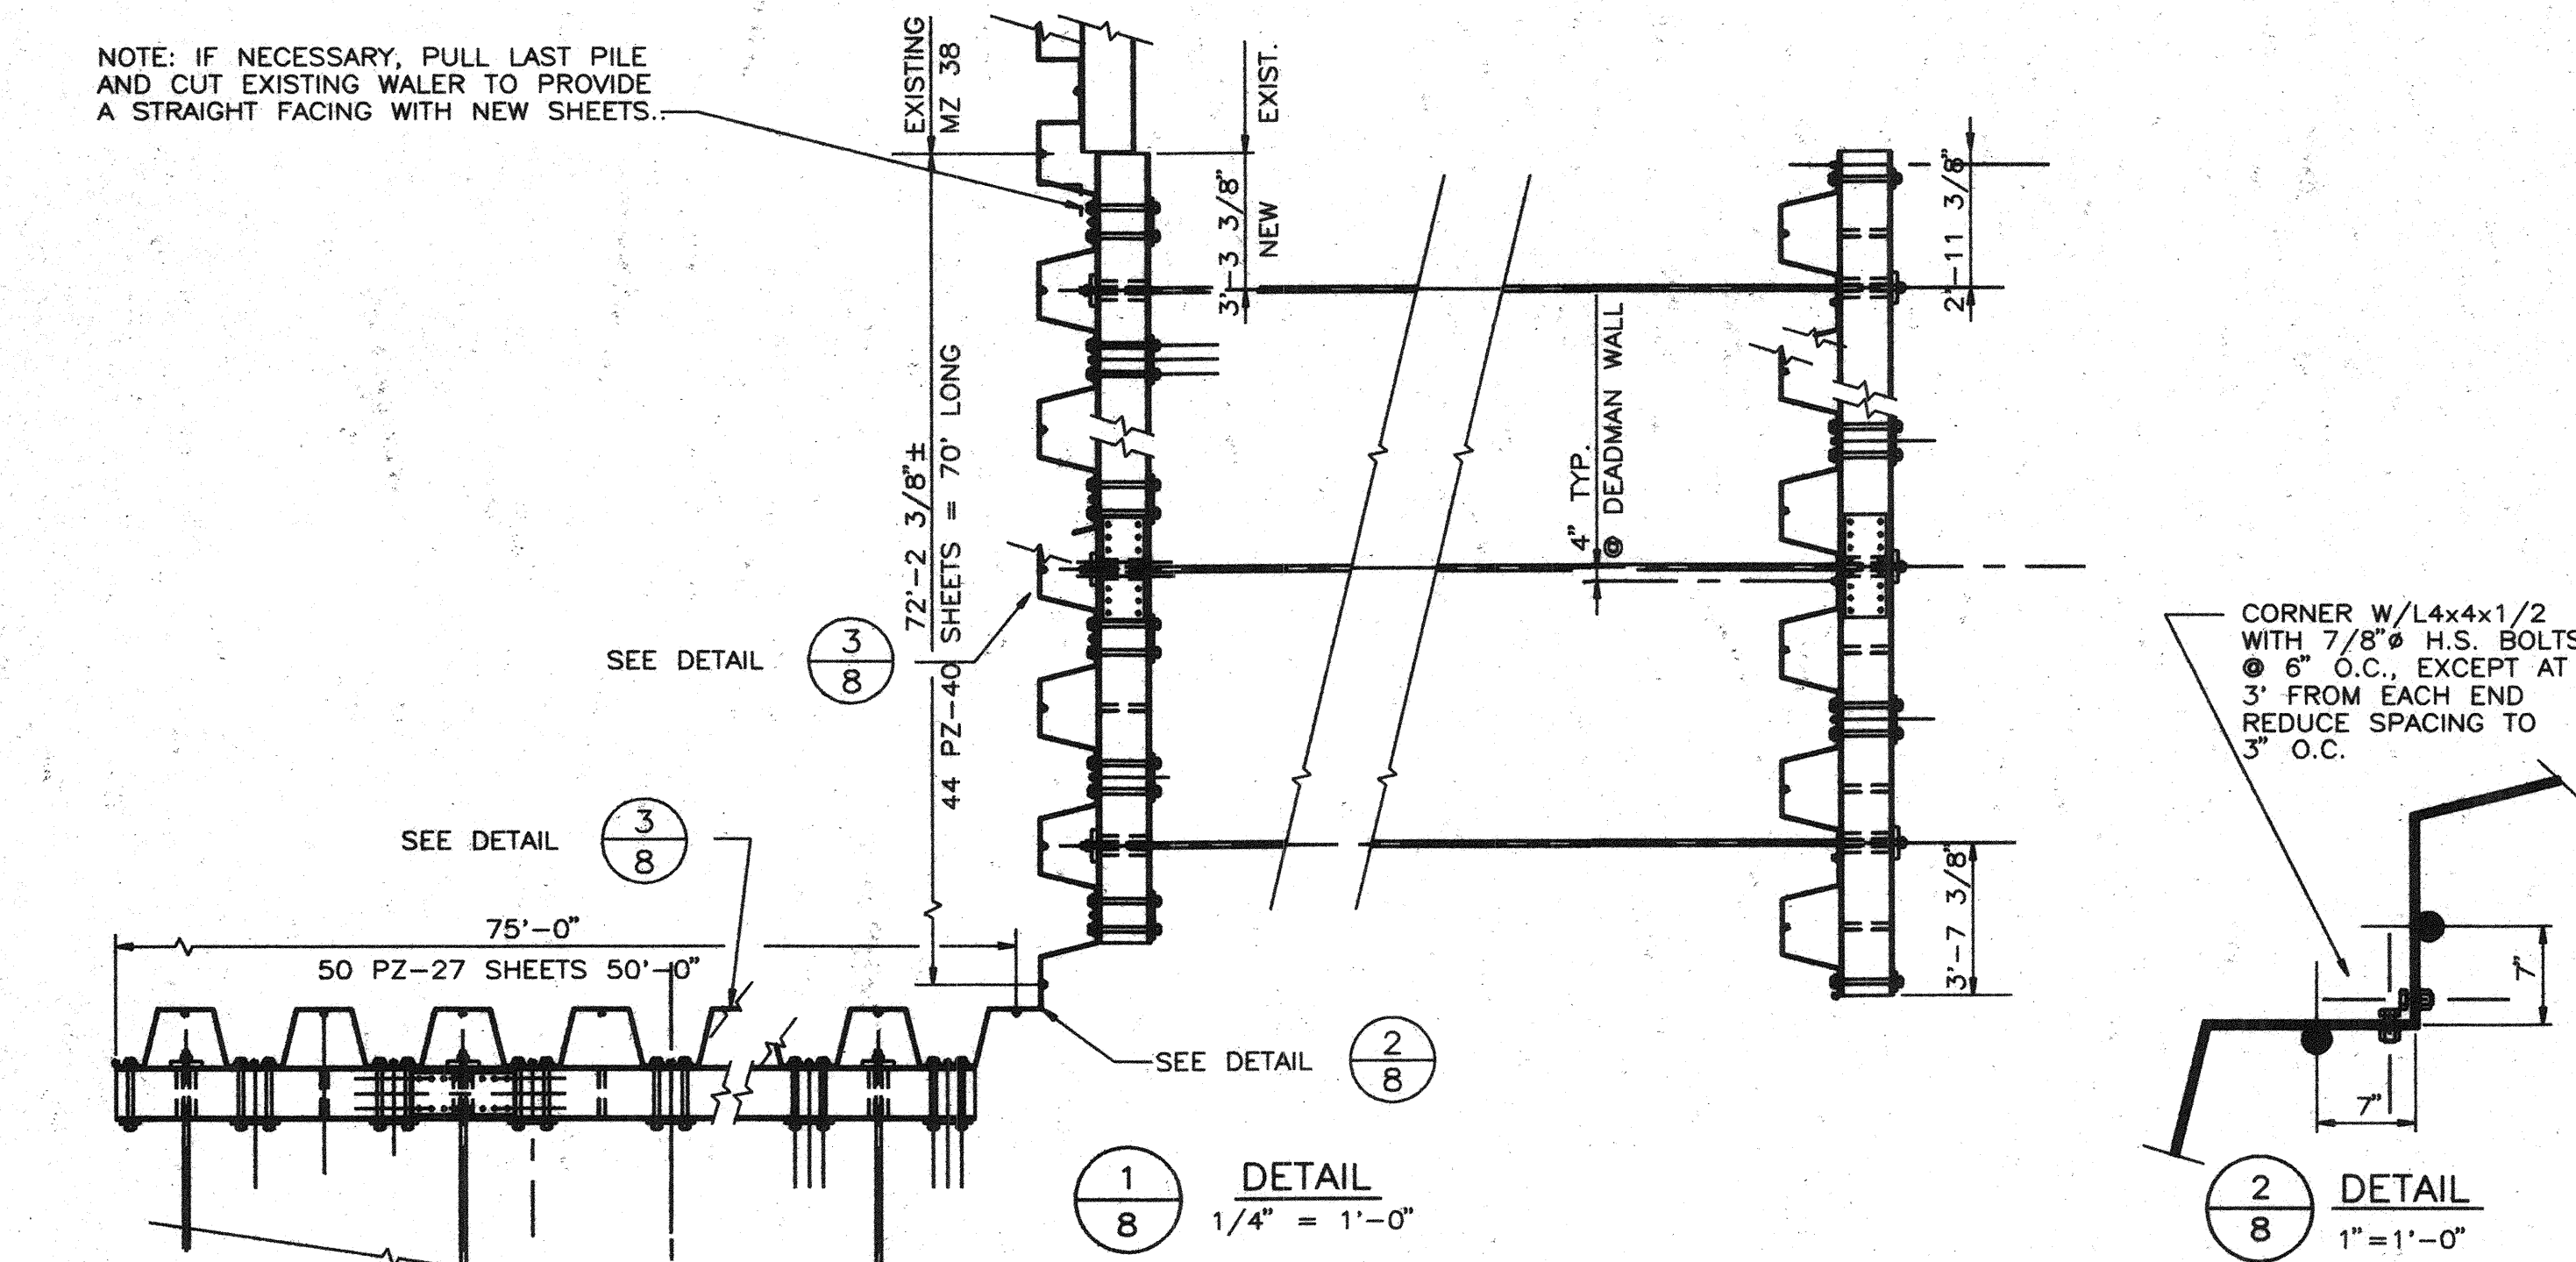

NOTES:  
 1.) FOR GENERAL NOTES SEE SHEET 2.  
 2.) TIMBER BULLRAIL SHALL BE TREATED SEE MISC. NOTE 1, SHEET 2.

No.	Date	By	Revision
2	3/4/92	WAJ	APPROVED FOR CONSTRUCTION ADDENDUM #3
1	1/7/92	WAJ	BID ISSUE ONLY

Turner  
 URS CONSULTANTS  
 POLYTECH

DESIGNED BY: WAJ	DATE: 5/8/91
DRAWN BY: H.HOLT	DATE: 5/8/91
CHECKED BY: GVD	DATE: 5/28/91
SCALE AS SHOWN	


DOCK 24W SLIP EXTENSION  
 CLEVELAND-CUYAHOGA COUNTY  
 PORT AUTHORITY

ANTHONY F. FUGARD, EXEC. DIRECTOR  
 JAY C. EHLE, CHAIRMAN OF THE BOARD


STRUCTURAL DETAILS  
 AND SECTIONS

PROJECT NO. 8921300


8 OF 13

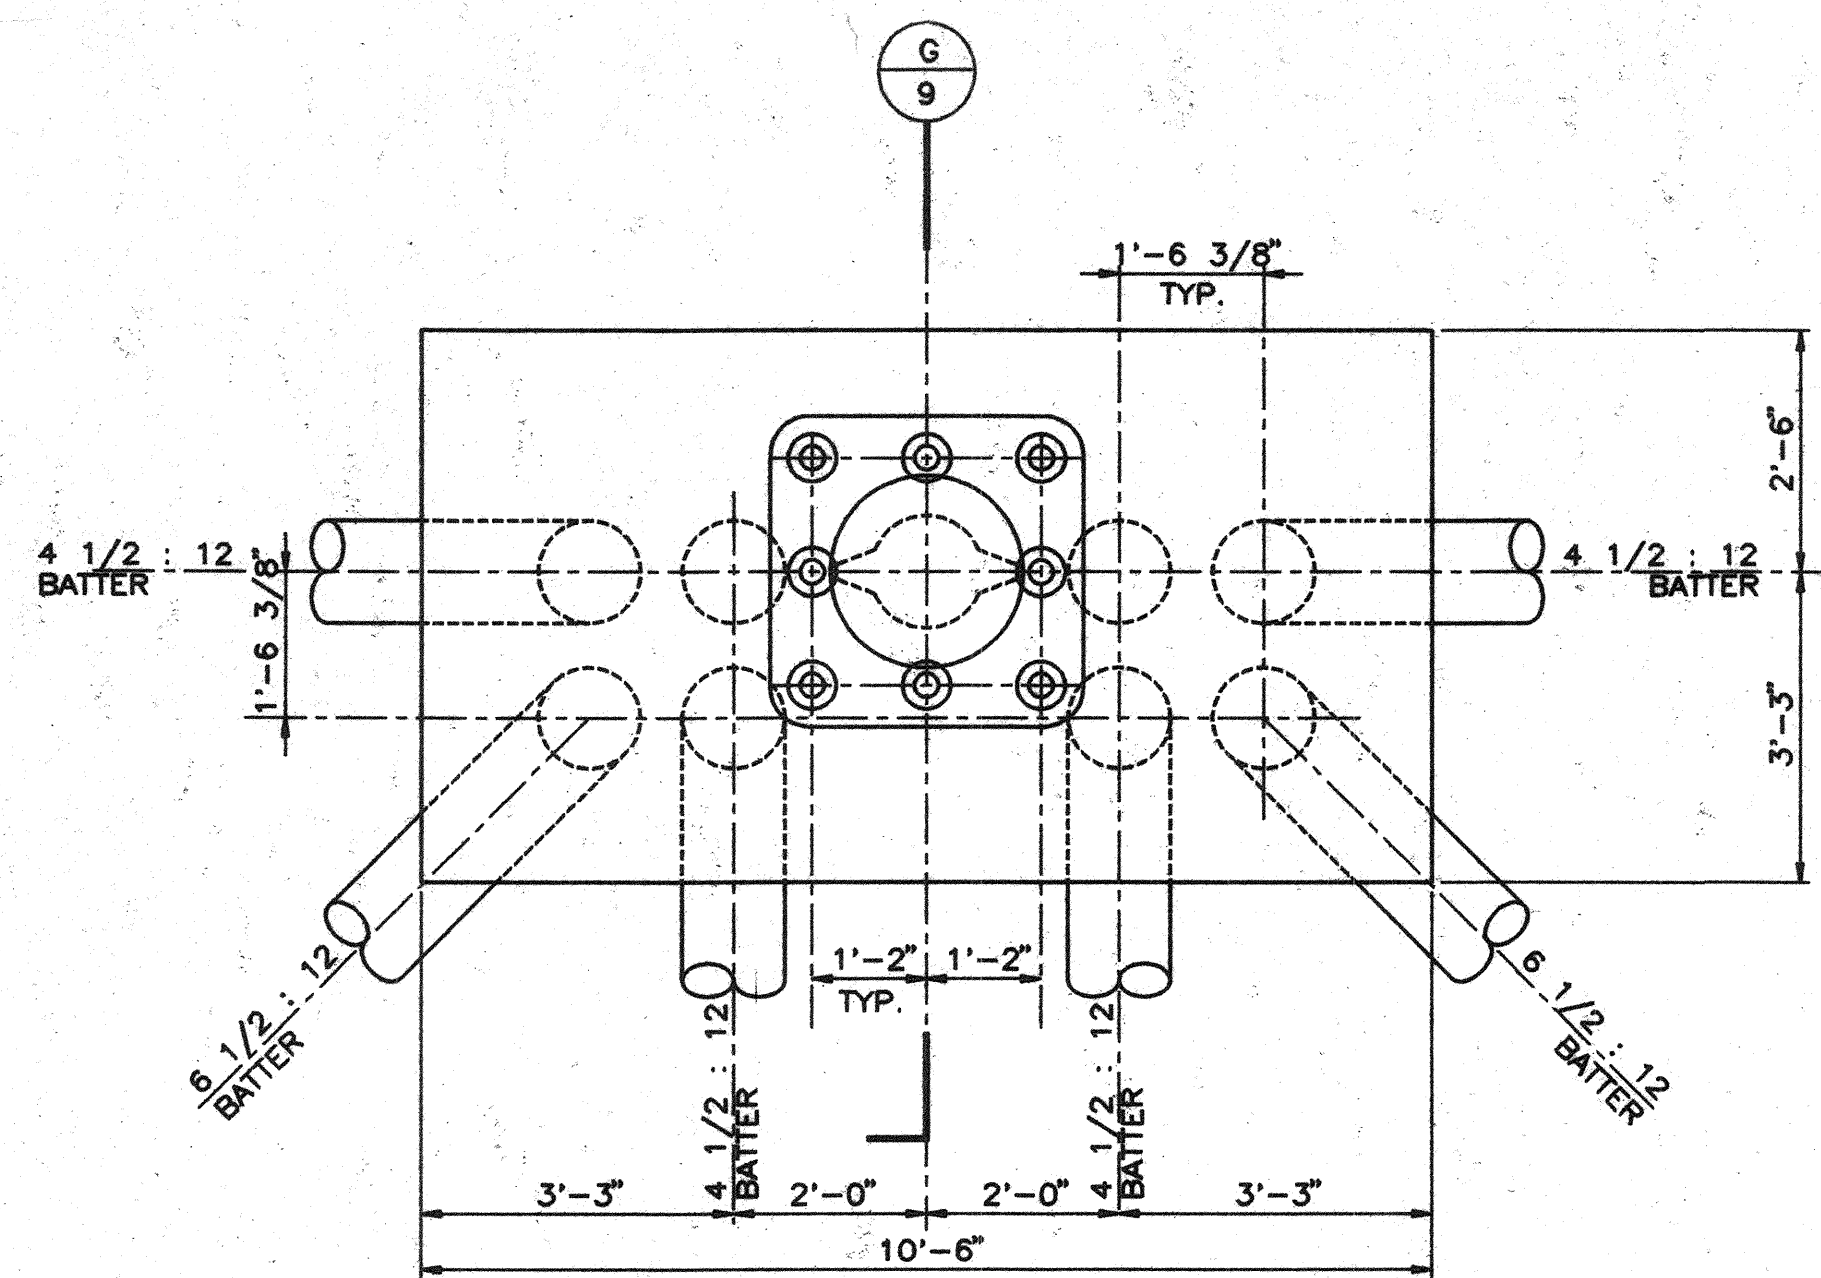


**BOLLARD PLAN**  
1/2" = 1'-0"

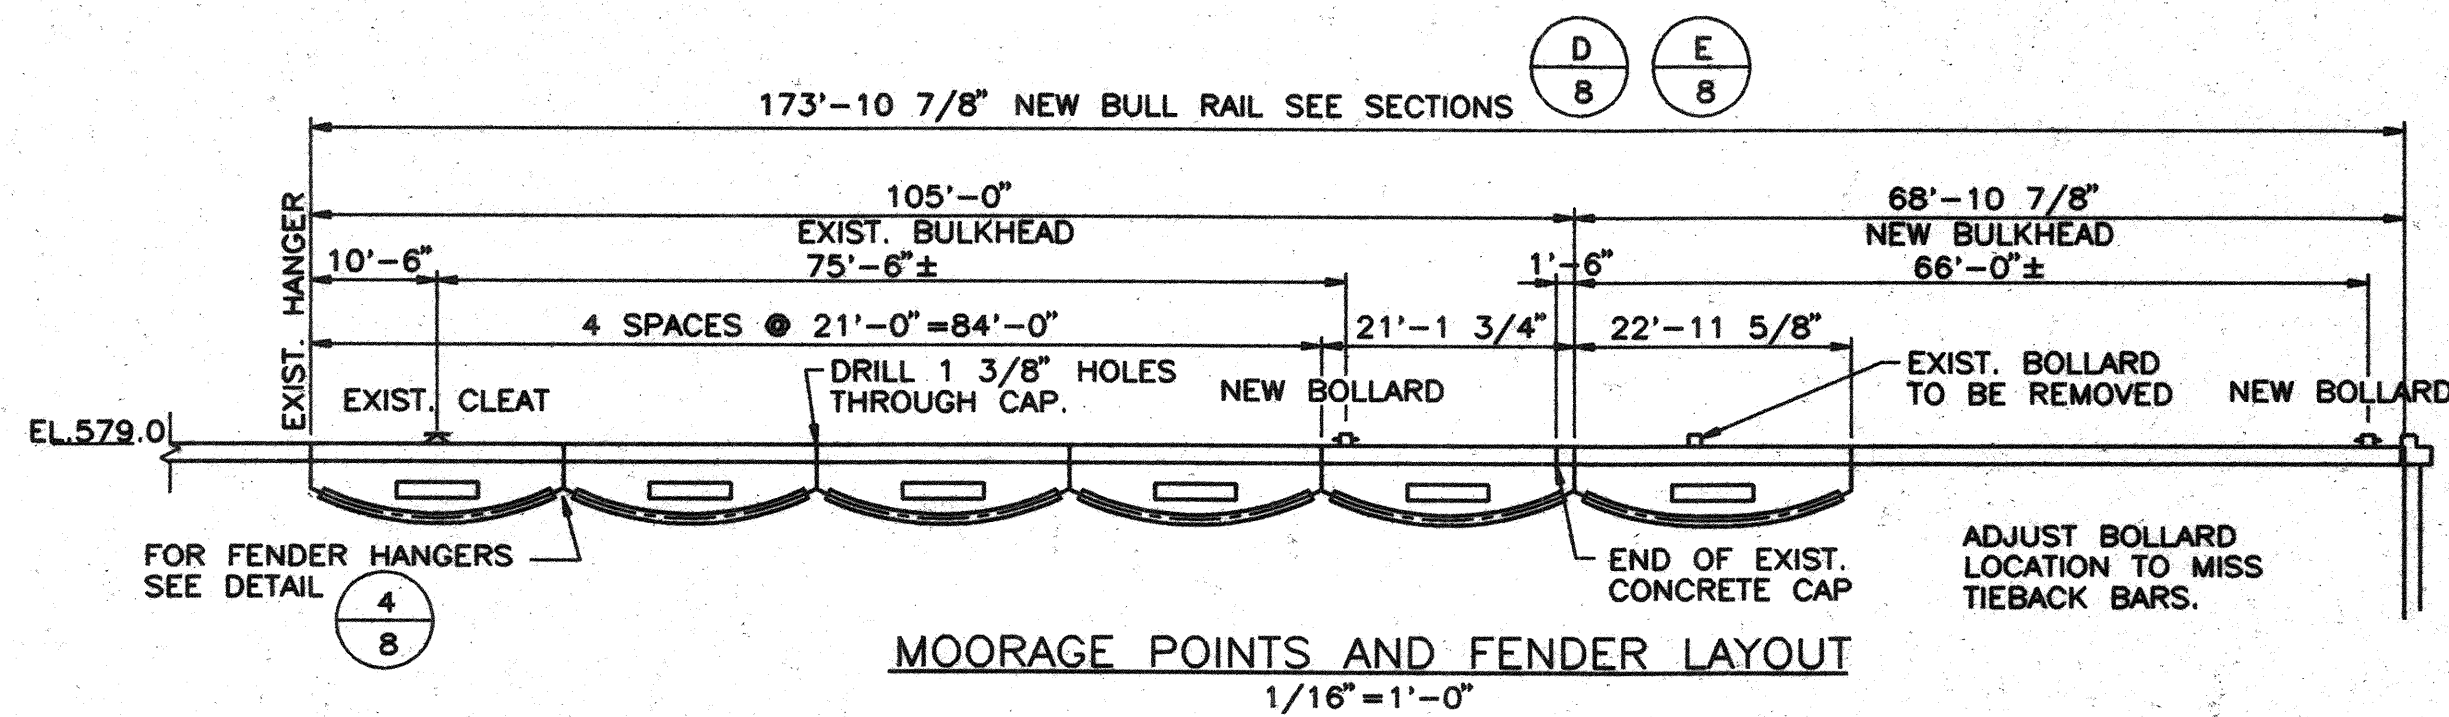


**MOORAGE POINTS AND FENDER LAYOUT**  
1/16" = 1'-0"

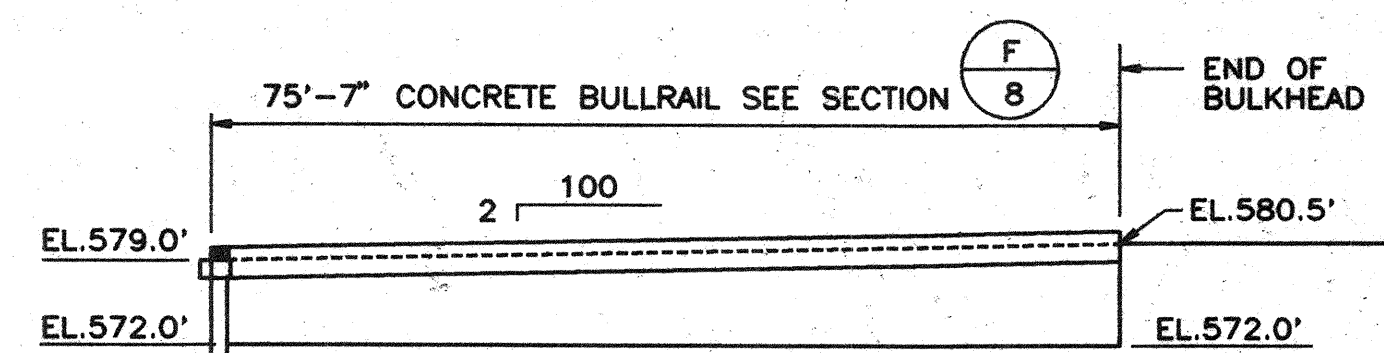

**ERIESIDE AVE. ELEVATION**  
1/16" = 1'-0"

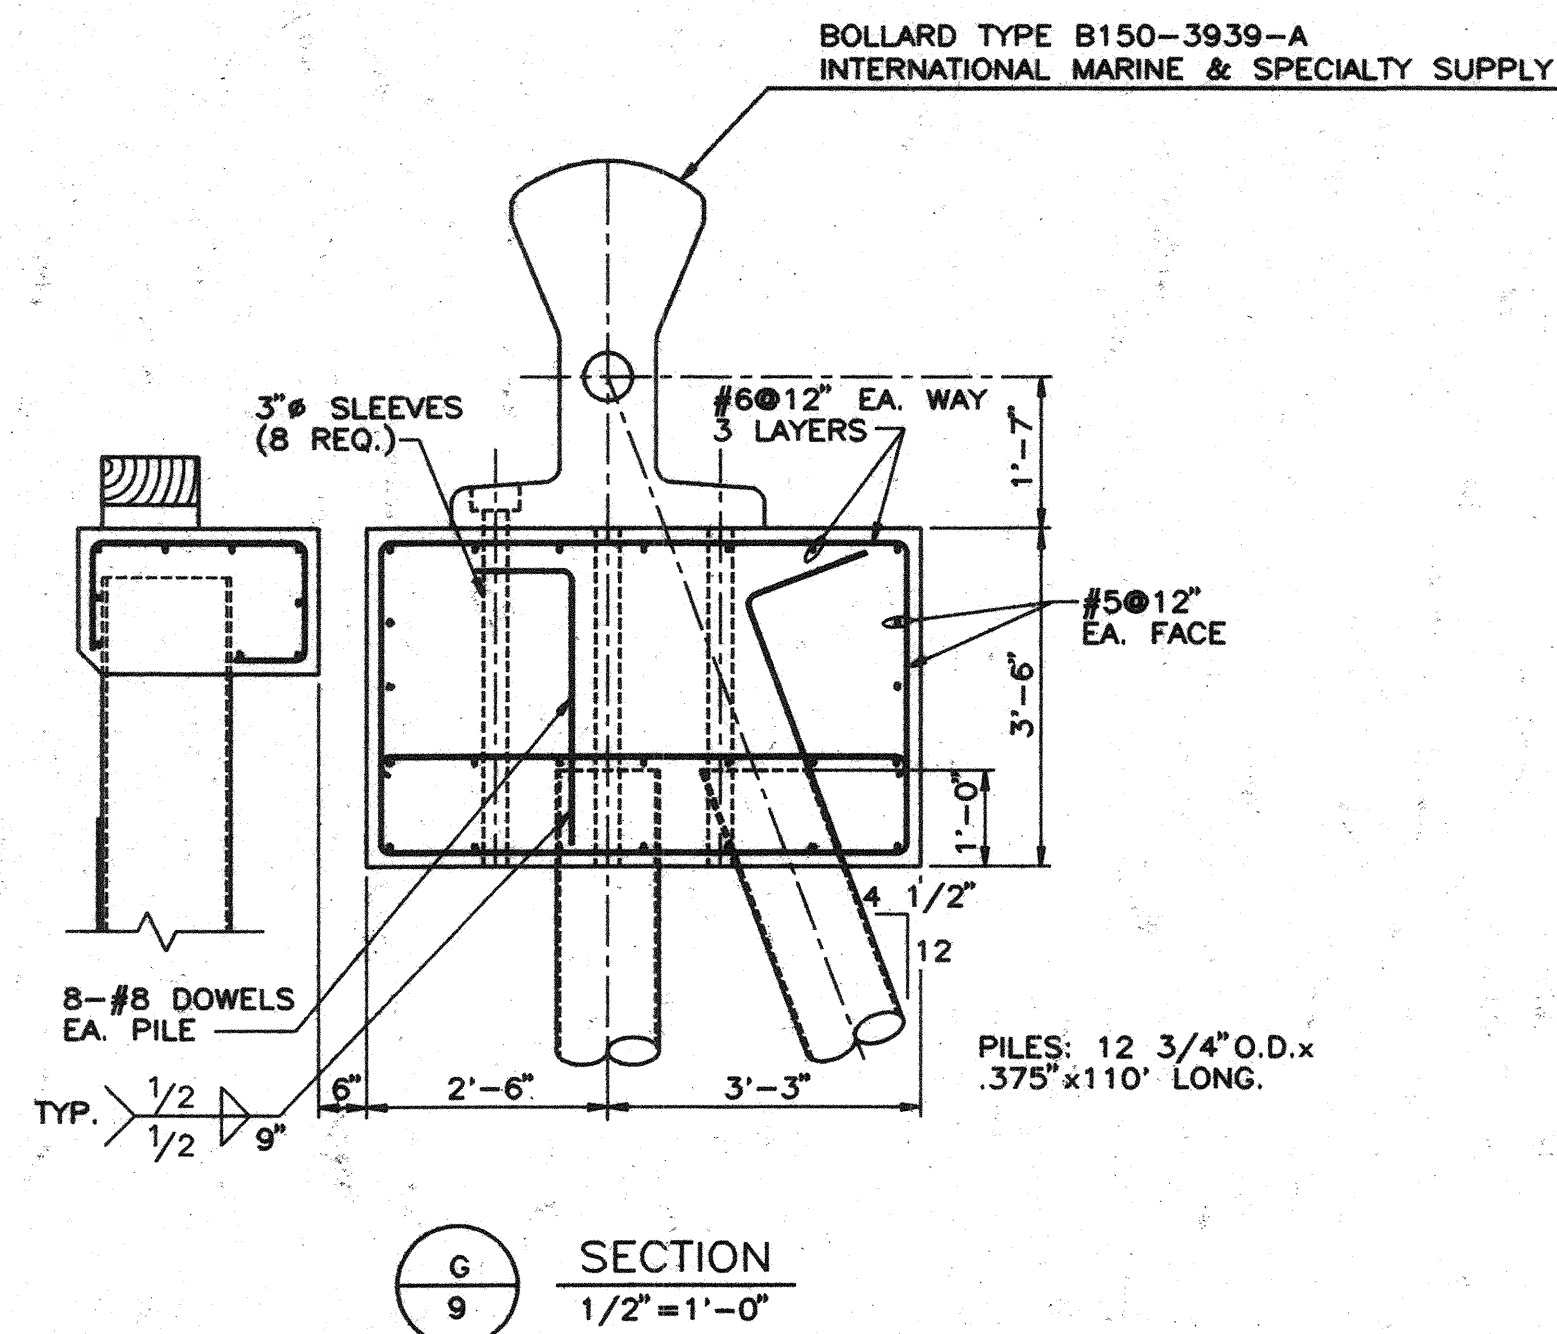

**SECTION**  
1/2" = 1'-0"

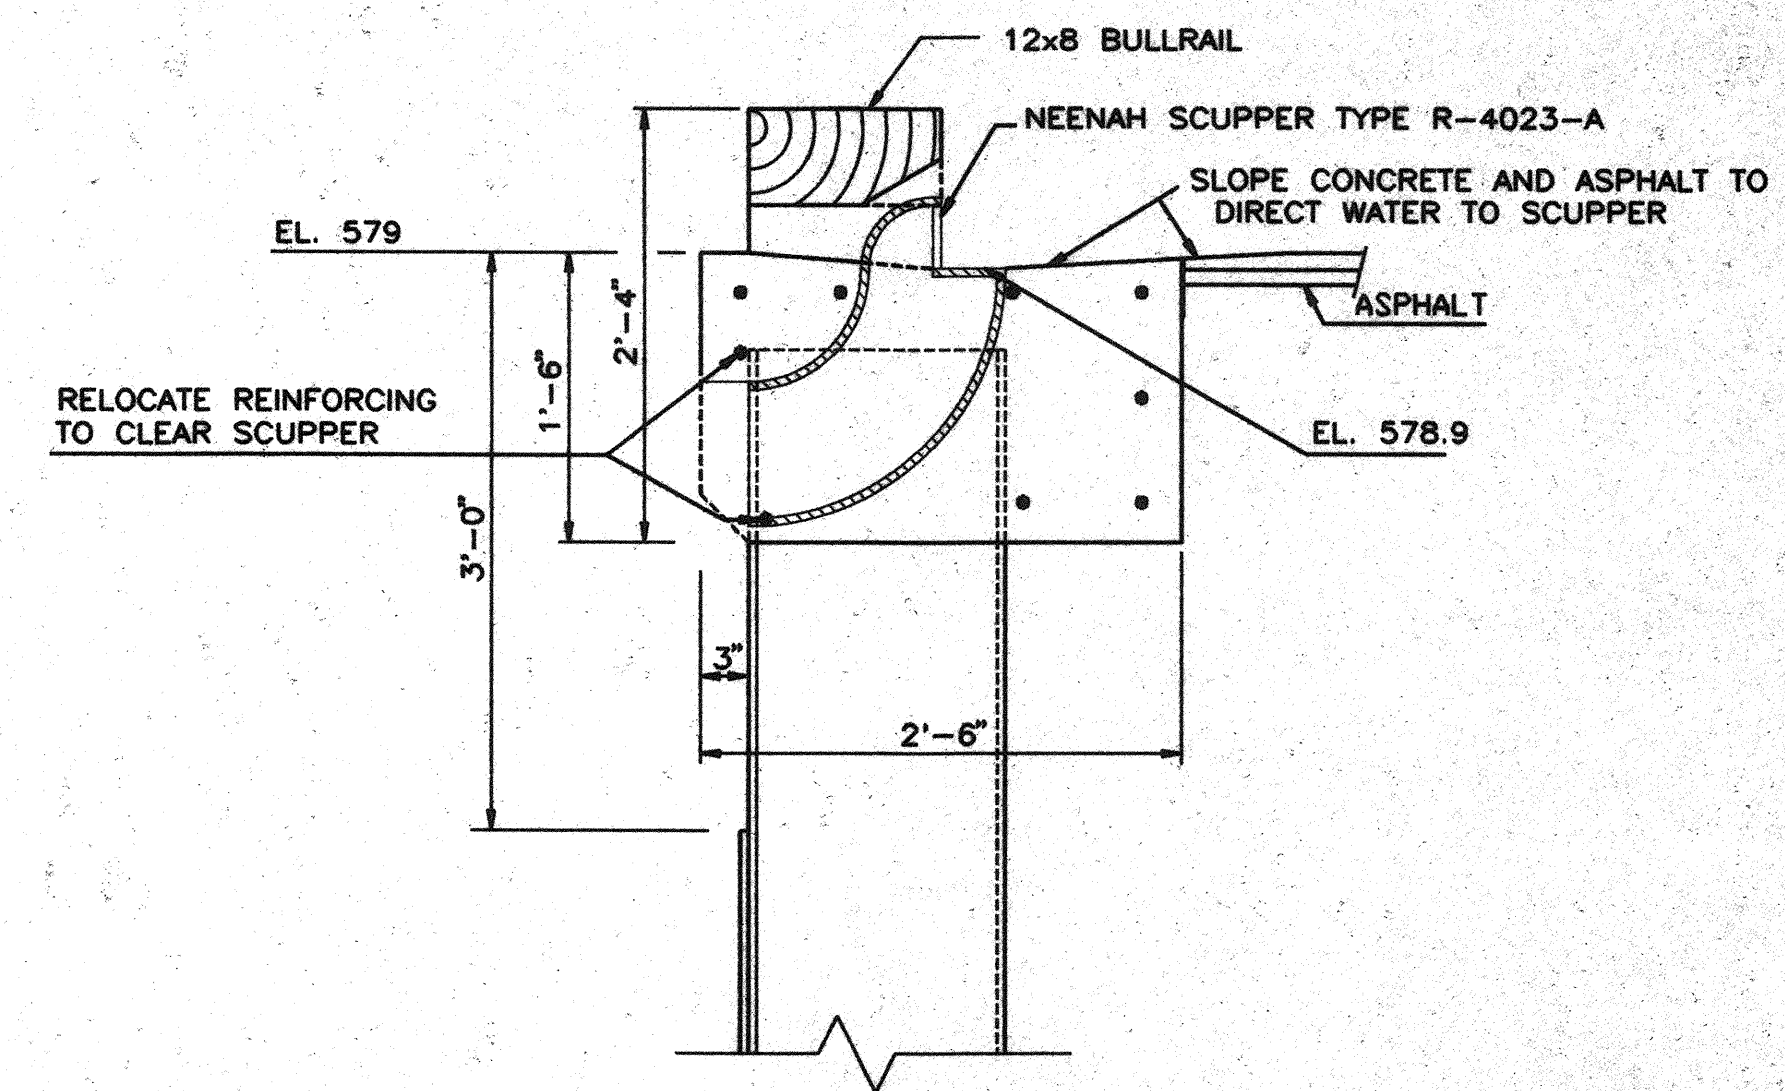

**SCUPPER DETAIL**  
1" = 1'-0"

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A	5/8/91	WAJ	FOR CLIENT REVIEW

Turner  
URS CONSULTANTS  
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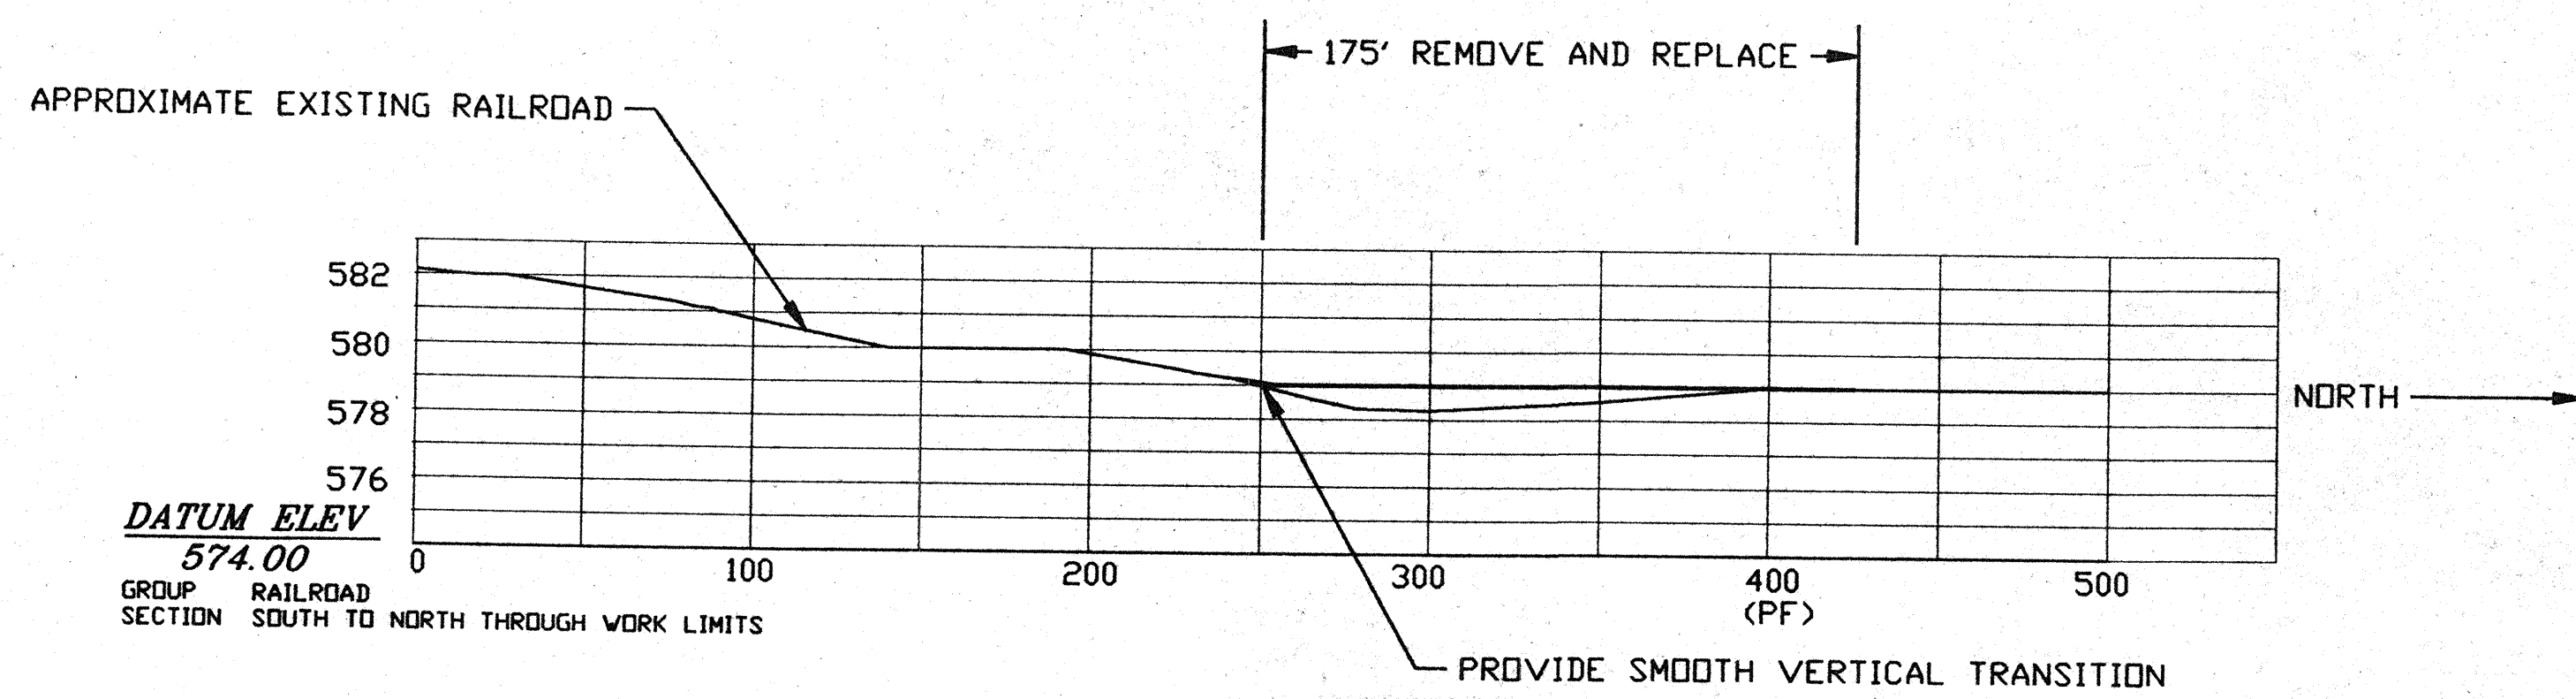
DESIGNED BY: WAJ	DATE: 5/8/91
DRAWN BY: P.FLURY	DATE: 5/8/91
CHECKED BY: DSP	DATE: 5/28/91
SCALE AS NOTED	

DOCK 24W SLIP EXTENSION  
CLEVELAND-CUYAHOGA COUNTY  
PORT AUTHORITY


ADDITIONAL MARINE  
DETAILS

ANTHONY F. FUGARD, EXEC. DIRECTOR  
JAY C. EHLE, CHAIRMAN OF THE BOARD


PROJECT NO. 8921300



RAILROAD PROFILE

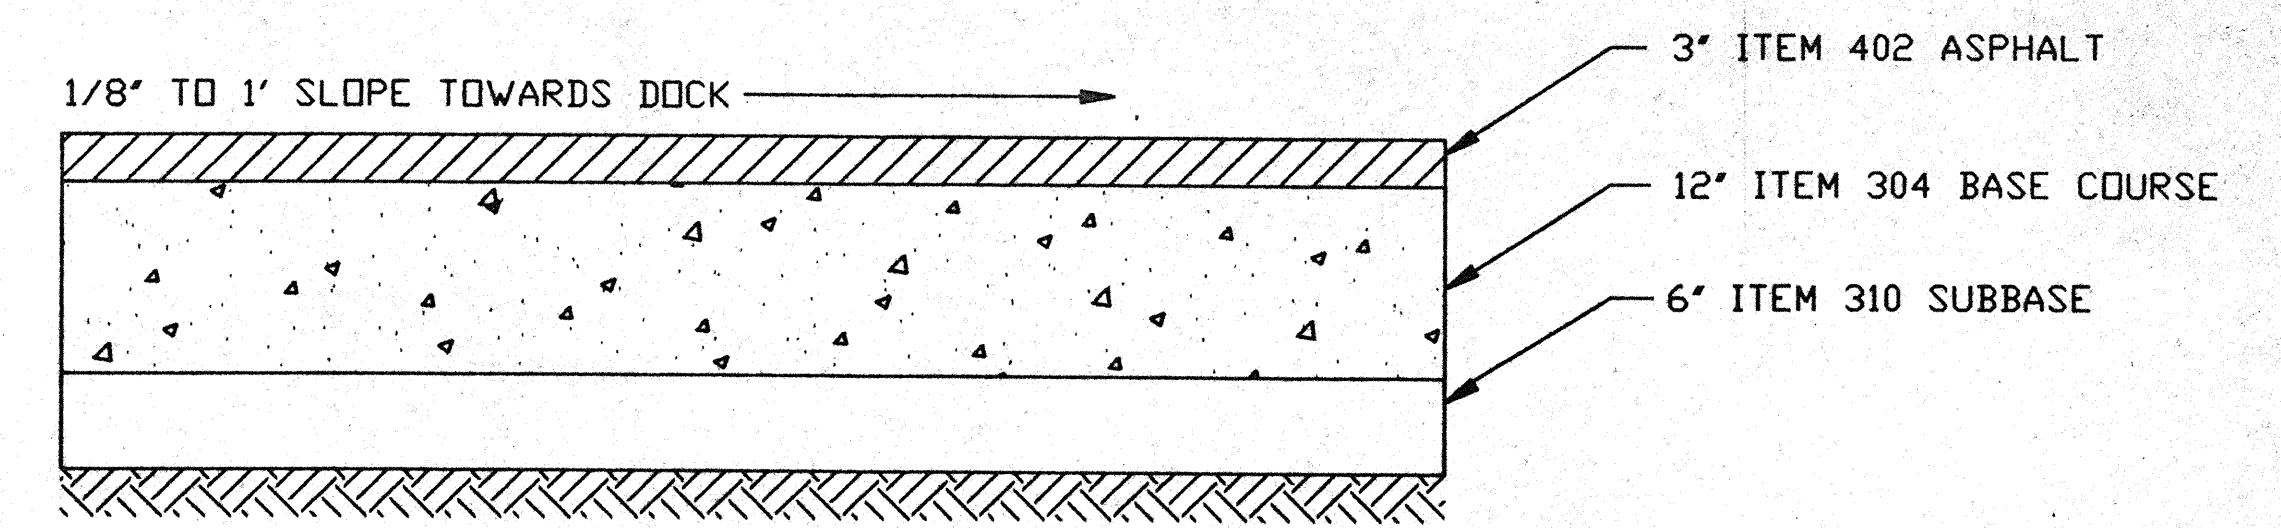


TYPICAL PAVEMENT SECTION

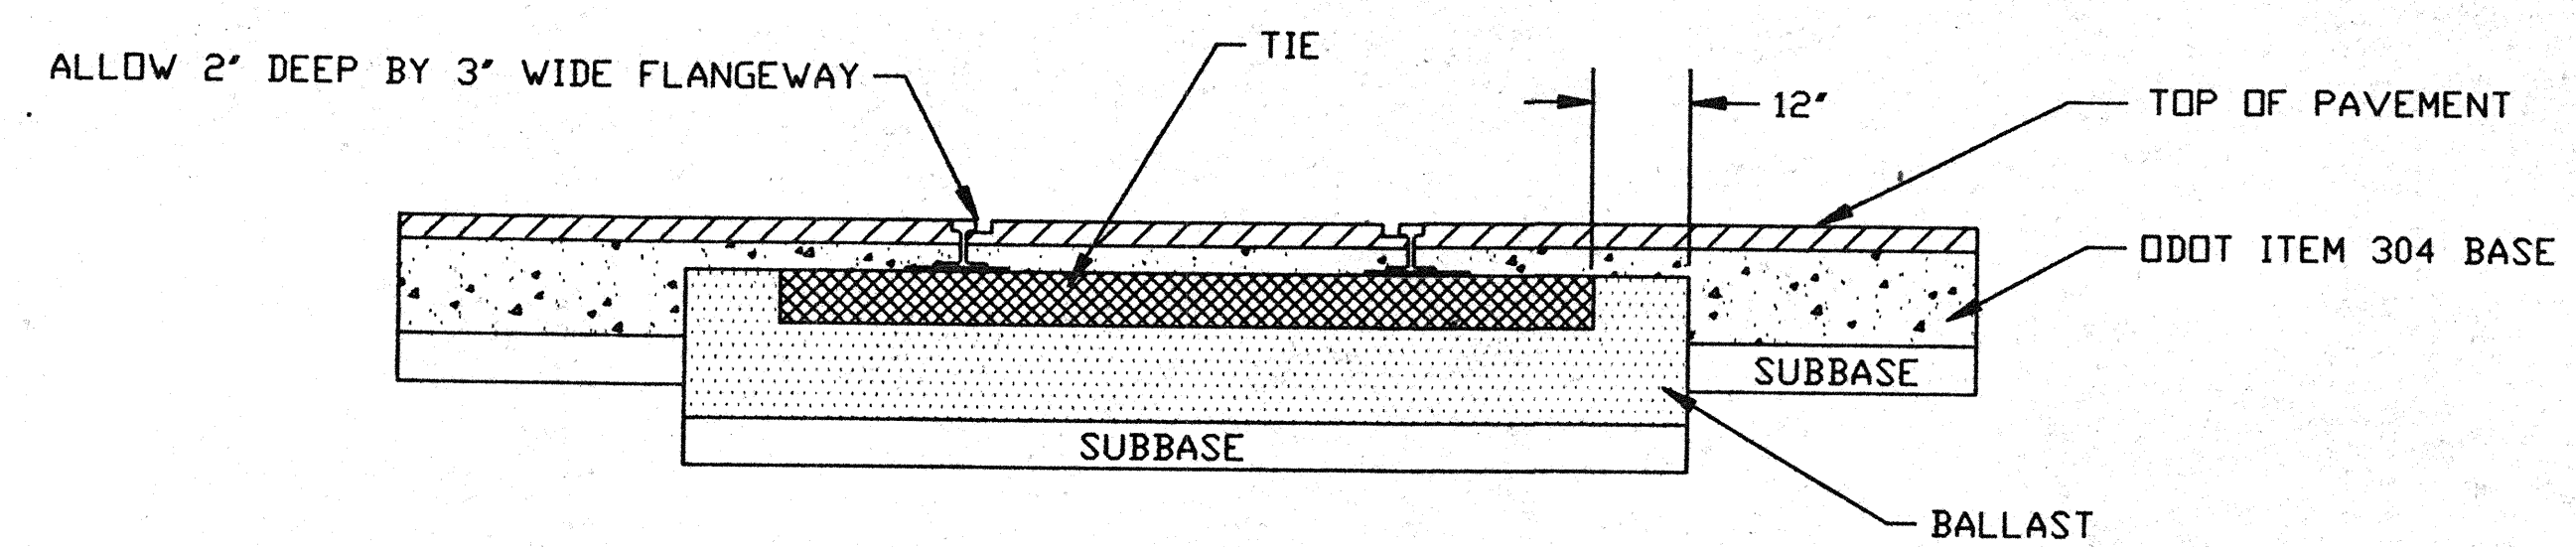


TYPICAL RAILROAD SECTION IN PAVEMENT

SCALE: 1/2" = 1'

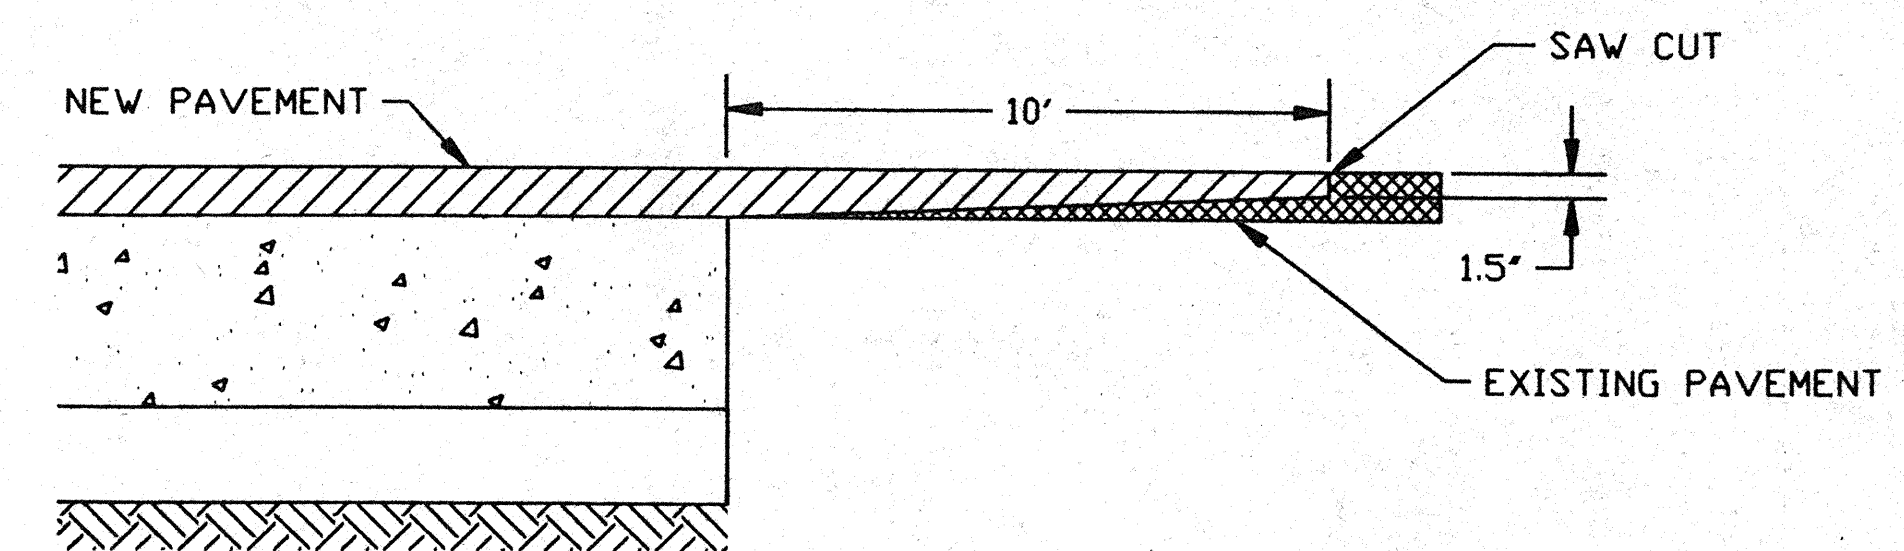


PAVEMENT JOINT DETAIL

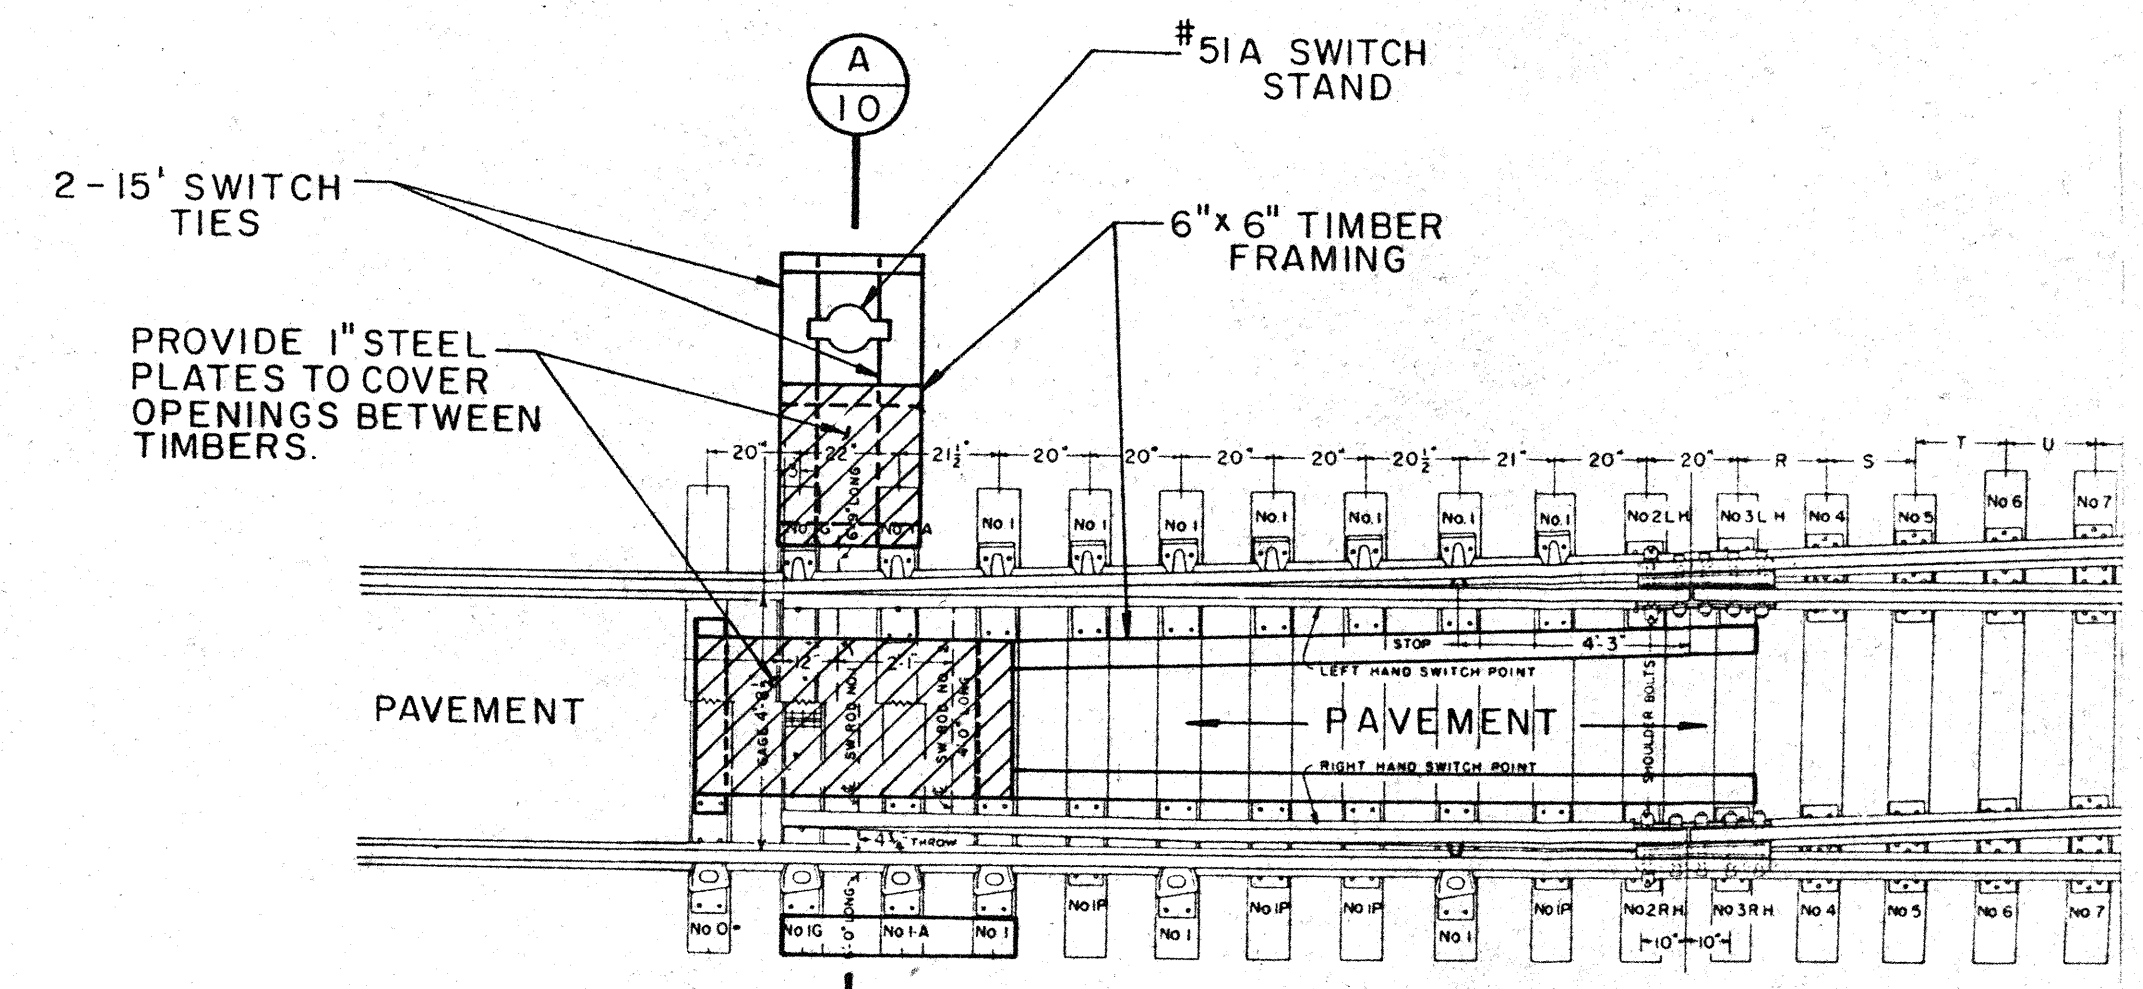

TURNOUT PLATE DETAIL

N. T. S.

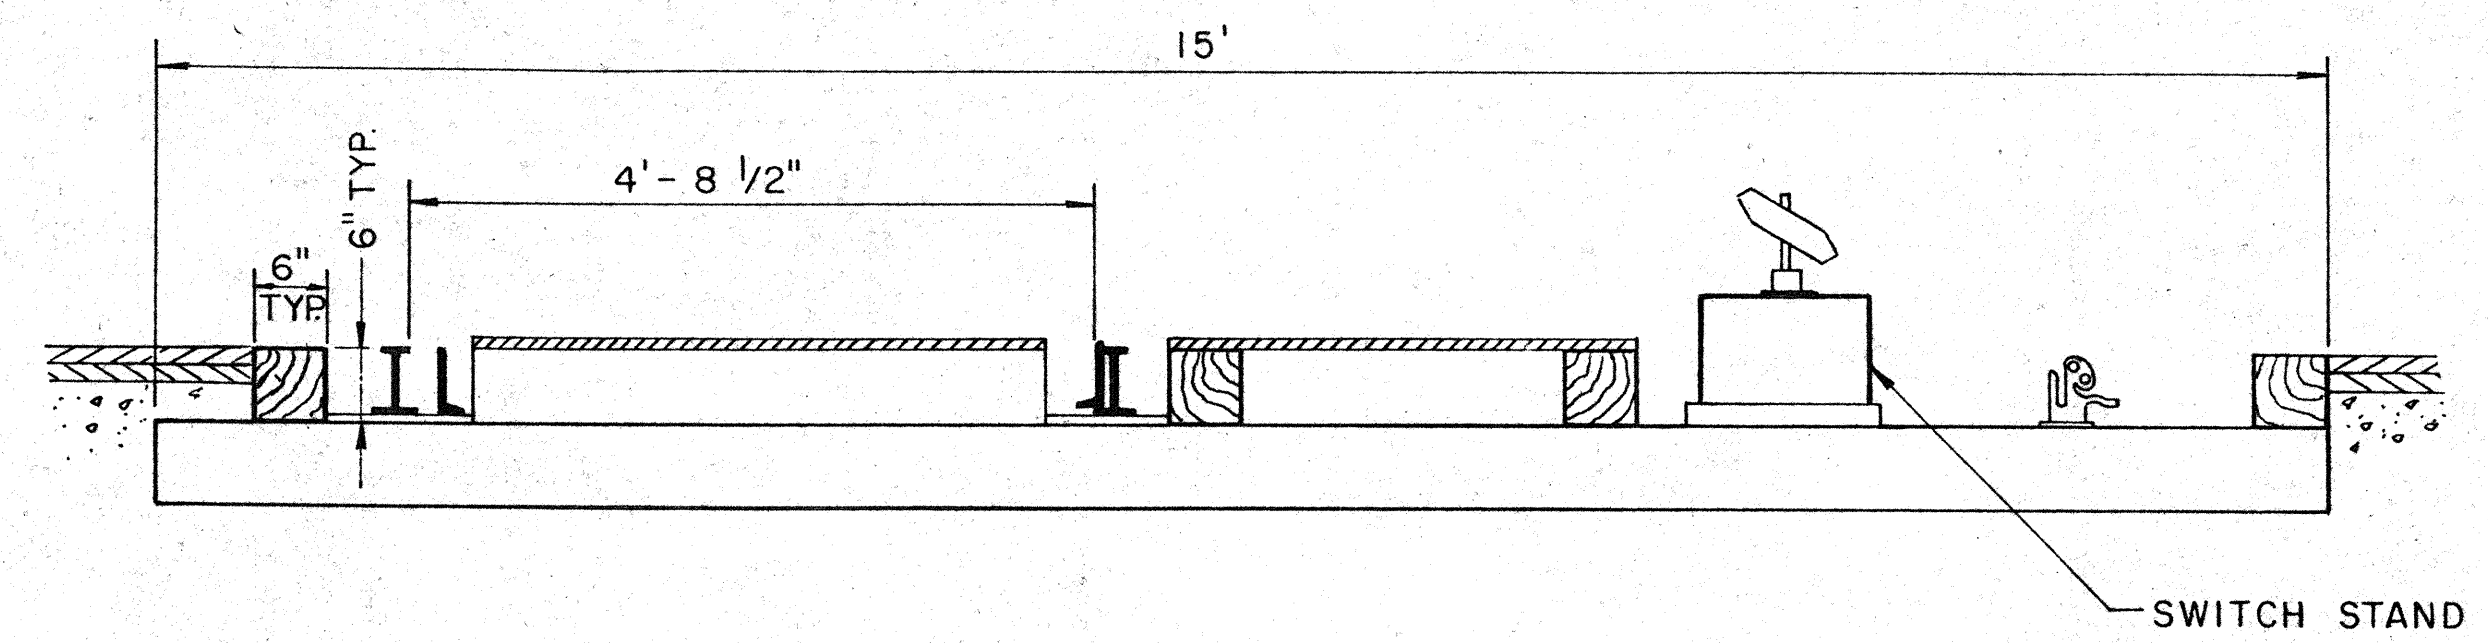

SECTION

NOTES

- 1) ALL FINISHED GRADES TO BE CONFIRMED FOR APPROVAL BY ENGINEER.
- 2) ALL PAVEMENT TO BE PLACED IN A SINGLE LIFT

No.	Date	By	Revision
1	1/13/92	PGP	BID ISSUE ONLY

Turner  
URS CONSULTANTS  
POLYTECH

DESIGNED BY: PGP	DATE: 5/17/91
DRAWN BY: PGP	DATE: 5/21/91
CHECKED BY: DSP	DATE: 5/21/91

DOCK 24W SLIP EXTENSION  
CLEVELAND-CUYAHOGA COUNTY  
PORT AUTHORITY


MISCELLANEOUS DETAILS

SCALE  
1" = 1' OR AS NOTED



ANTHONY F. FUGARD, EXEC. DIRECTOR  
JAY C. EHLE, CHAIRMAN OF THE BOARD

PROJECT NO. 8921300



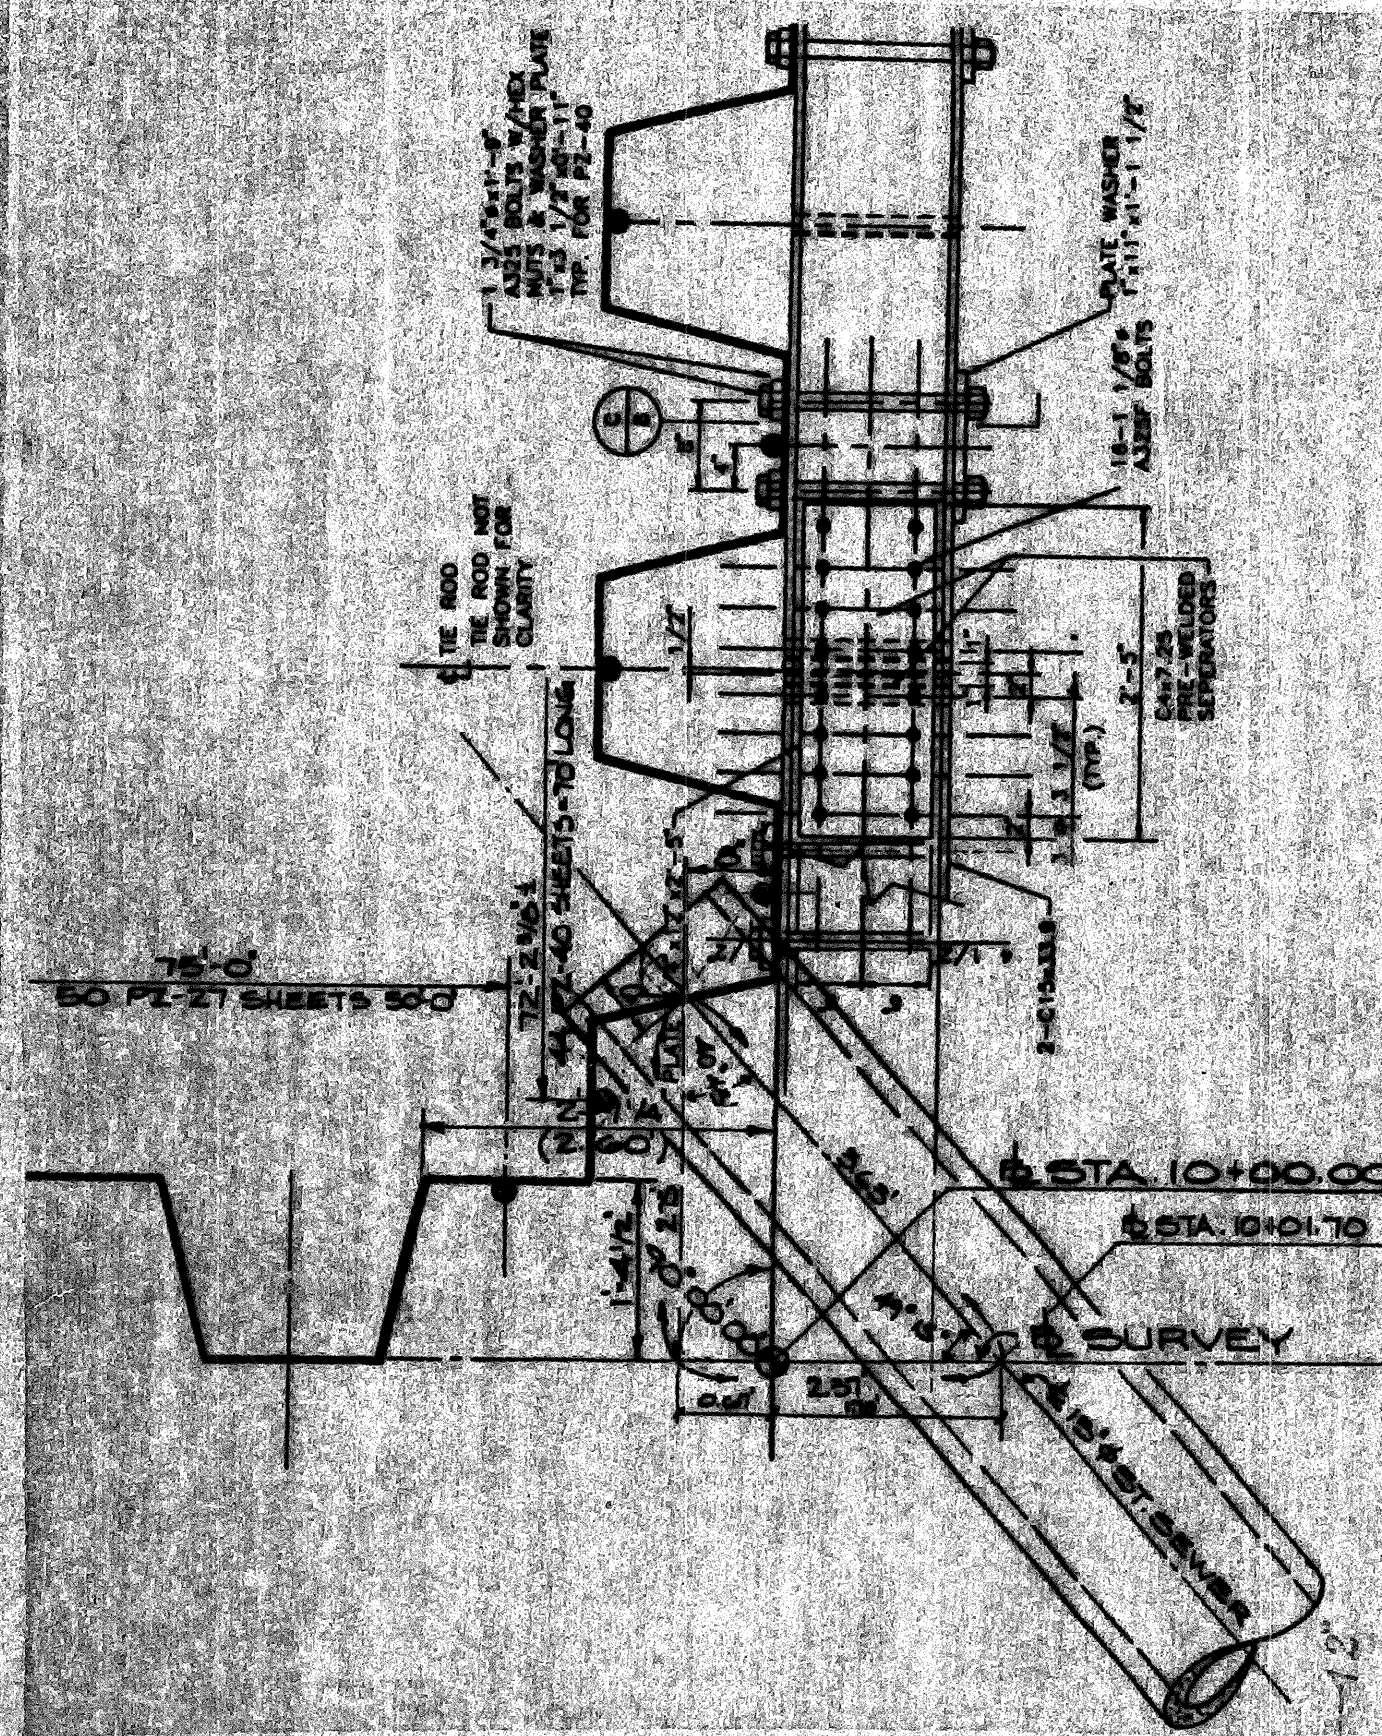

**DETAIL - 15' OUTLET PIPE  
(FOR STORM SEWER)  
NO SCALE**

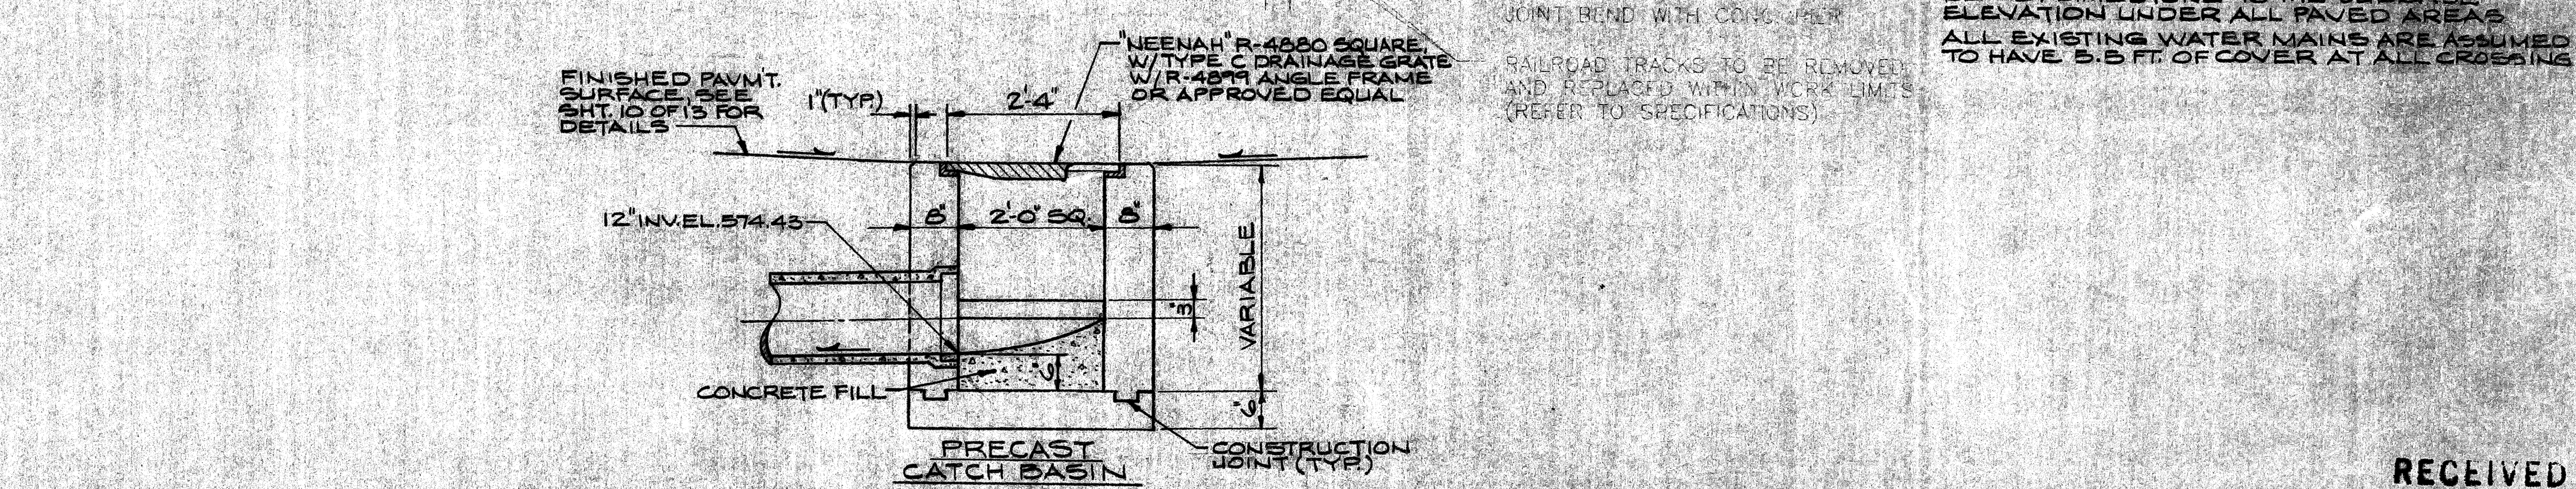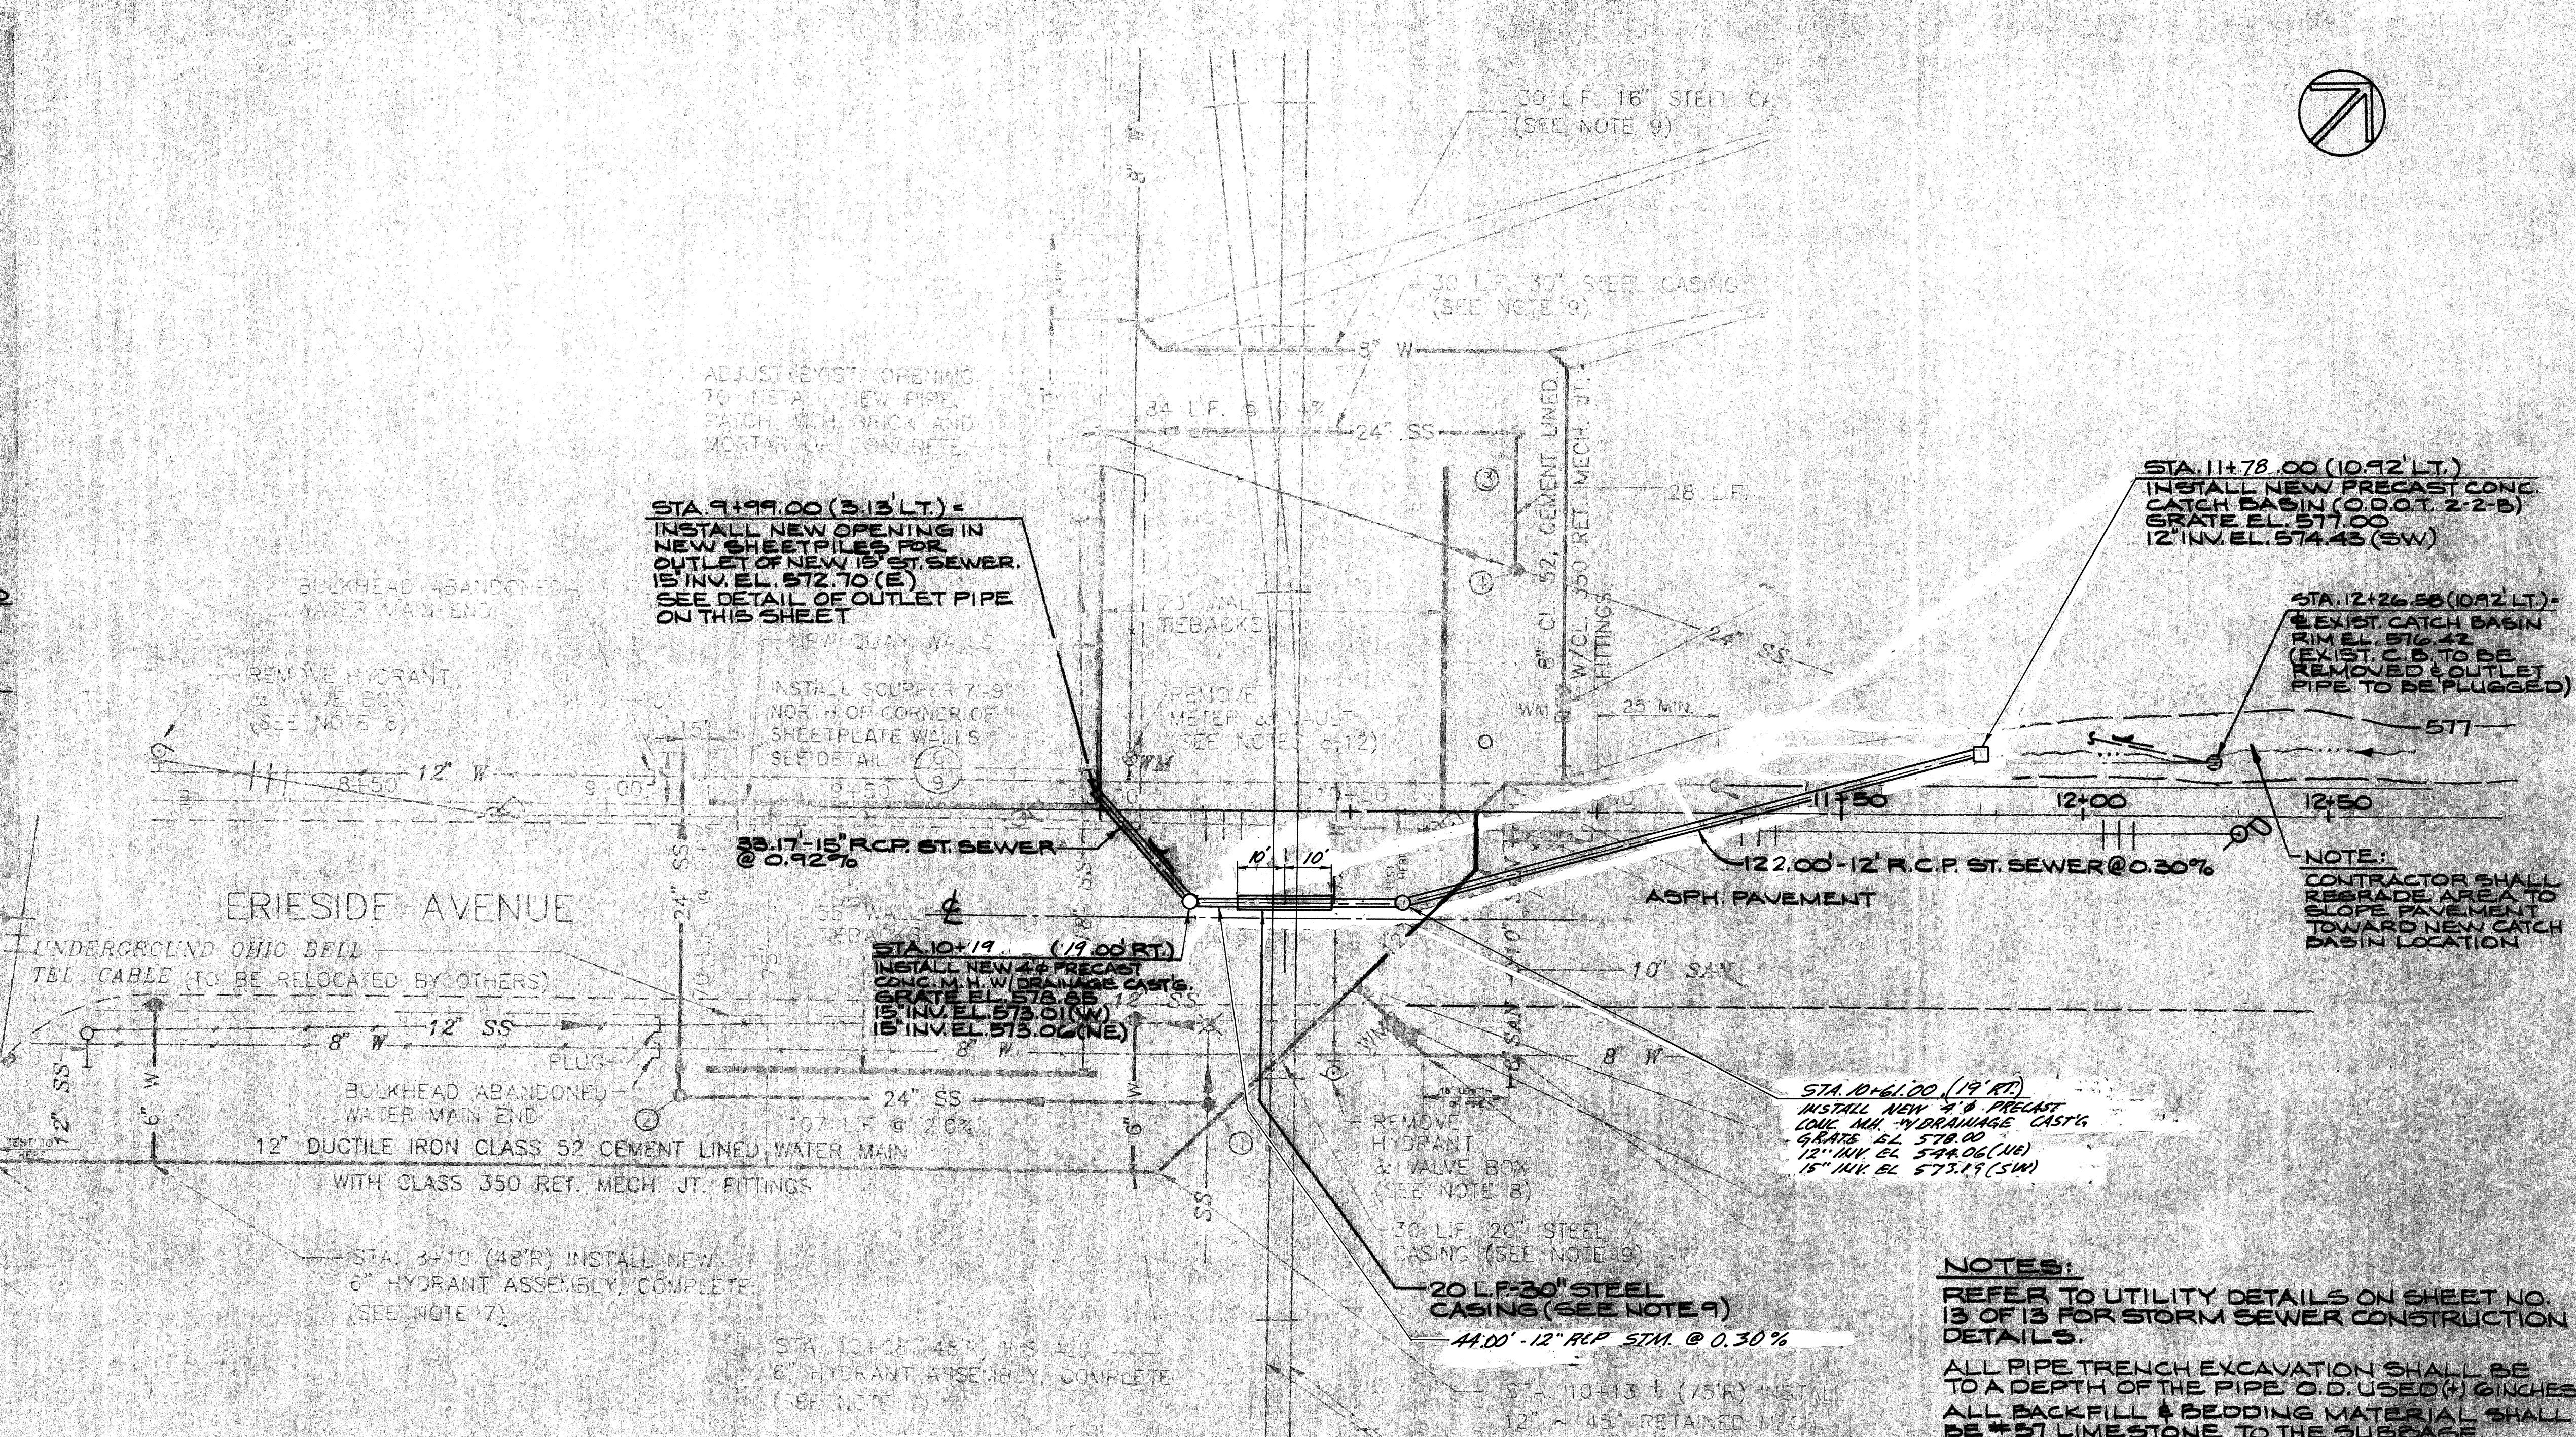

LEGEND	
EXISTING	PROPOSED
	MANHOLE IDENTIFICATION (SEE SHEET 13)

**NOTES:**  
REFER TO UTILITY DETAILS ON SHEET NO. 13 OF 13 FOR STORM SEWER CONSTRUCTION DETAILS.  
ALL PIPE TRENCH EXCAVATION SHALL BE TO A DEPTH OF THE PIPE O.D. USED (+) 6 INCHES  
ALL BACKFILL & BEDDING MATERIAL SHALL BE #57 LIMESTONE TO THE SUBBASE ELEVATION UNDER ALL PAVED AREAS  
ALL EXISTING WATER MAINS ARE ASSUMED TO HAVE 3.5 FT. OF COVER AT ALL CROSSING

No.	Date	By	Revision
4	5-19-92	PGP	REVISED LOCATION OF ST. SEWER FOR ERIESIDE AVE.
3	3/2/92	PGP	CONSTRUCTION ISSUE
2	1/13/91		NORTH SCUPPER DELETED
1	5/28/91		REVISED LOCATION OF NEW 8" W. ADDED LOCATION OF SCUPPERS. REVISED WORDING.


Turner  
URS CONSULTANTS  
POLYTECH

DESIGNED BY:	DATE:
D.R.B.	5/91
DRAWN BY:	DATE:
D.R.B.	5/91
CHECKED BY:	DATE:
E.D.V.	5/91
SCALE 1"=20'	

DOCK 24W  
SLIP EXTENSION  
CLEVELAND-CUYAHOGA COUNTY  
PORT AUTHORITY

UTILITIES PLAN  
RECEIVED  
SEP 21 1992  
TURNER CONSTRUCTION COMPANY  
CHIEF ENGINEER  
DIRECTOR  
PROJECT NO.  
SHEET NO.  
11 of 13



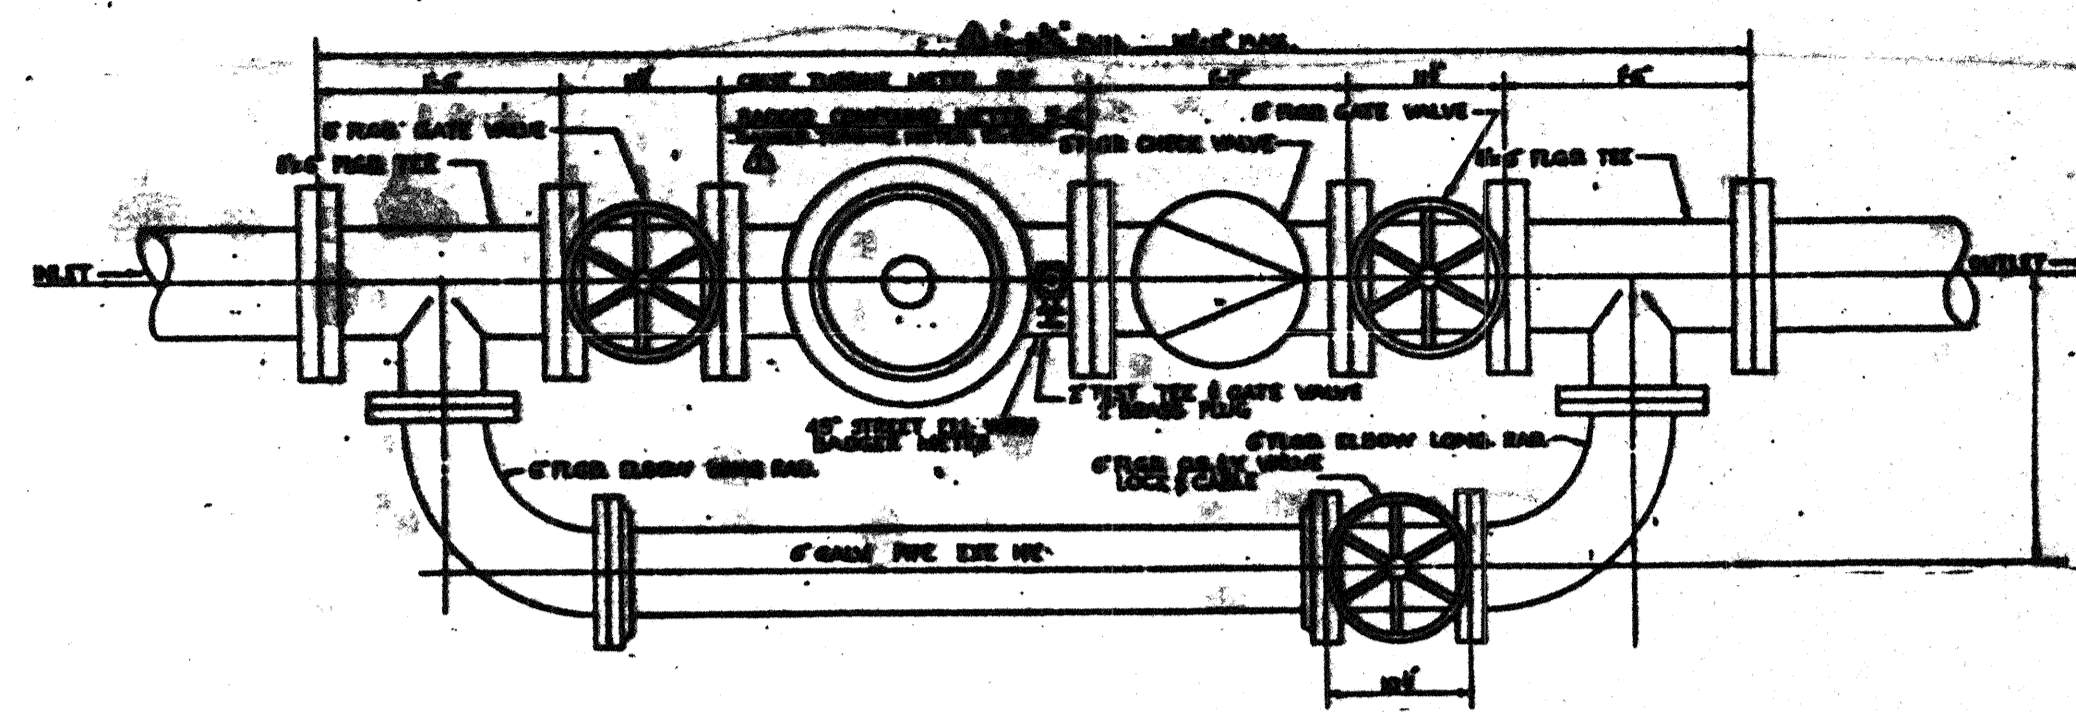

B-1698

REVISED 7-11-86

8" METER SETTING

MATERIALS REQUIRED FOR INSTALLATION


8" CONNECTION FOR GENERAL OR FIRE PROTECTION SERVICE

- 1 SCH 40 X 8" Branch Sleeve - (Square Seal or Mechanical Joint)
- 1 8" Cast Iron Top Valve with Ball Outlet
- 1 8" Square Head Gate Valve
- 1 #2 Valve Box Top
- 1 #2 Valve Box Cover
- 1 #2 Valve Box Bottom
- 1 8" Connection Piece, P-S, OR 1-8" Connection Piece, P-B, OR 1-8" Flanged Coupling Adapter
- 8ft Ductile Iron, Class 56 Cement Lined Pipe
- 1# Pig Lead (If Required)


8" METER SETTING

- 1 2" H.W. Gate Valve, Screwed
- 2 8" Flange Gaskets
- 8 3/4"x3/4" Machine Bolts
- 8 3/4"x3-3/4" Stud Bolts
- 16 3/4" Hex Nuts
- 1 2"x10" Brass Nipple
- 1 6" O.S.Y. Valve, Flanged
- 2 8" H.W. Gate Valves, Flanged
- 1 8" Spring Gate Check Valve, Flanged
- 2 8"x6" Cast Iron Tees, Flanged, LR
- 2 6" Cast Iron Elbows, Flanged, LR
- 2 6"x11" Flange, Cast Iron, 8 Hole
- 5 8" Gaskets
- 7 6" Gaskets
- 40 3/4"x3" Machine Bolts
- 48 3/4"x3/4" Machine Bolts
- 8 3/4"x3-3/4" Stud Bolts
- 16 3/4" Hex Nuts
- 72" 6" Galvanized Pipe-Extra Heavy CURRENT Meter
- 1 8"

\*SCH means Size of Main

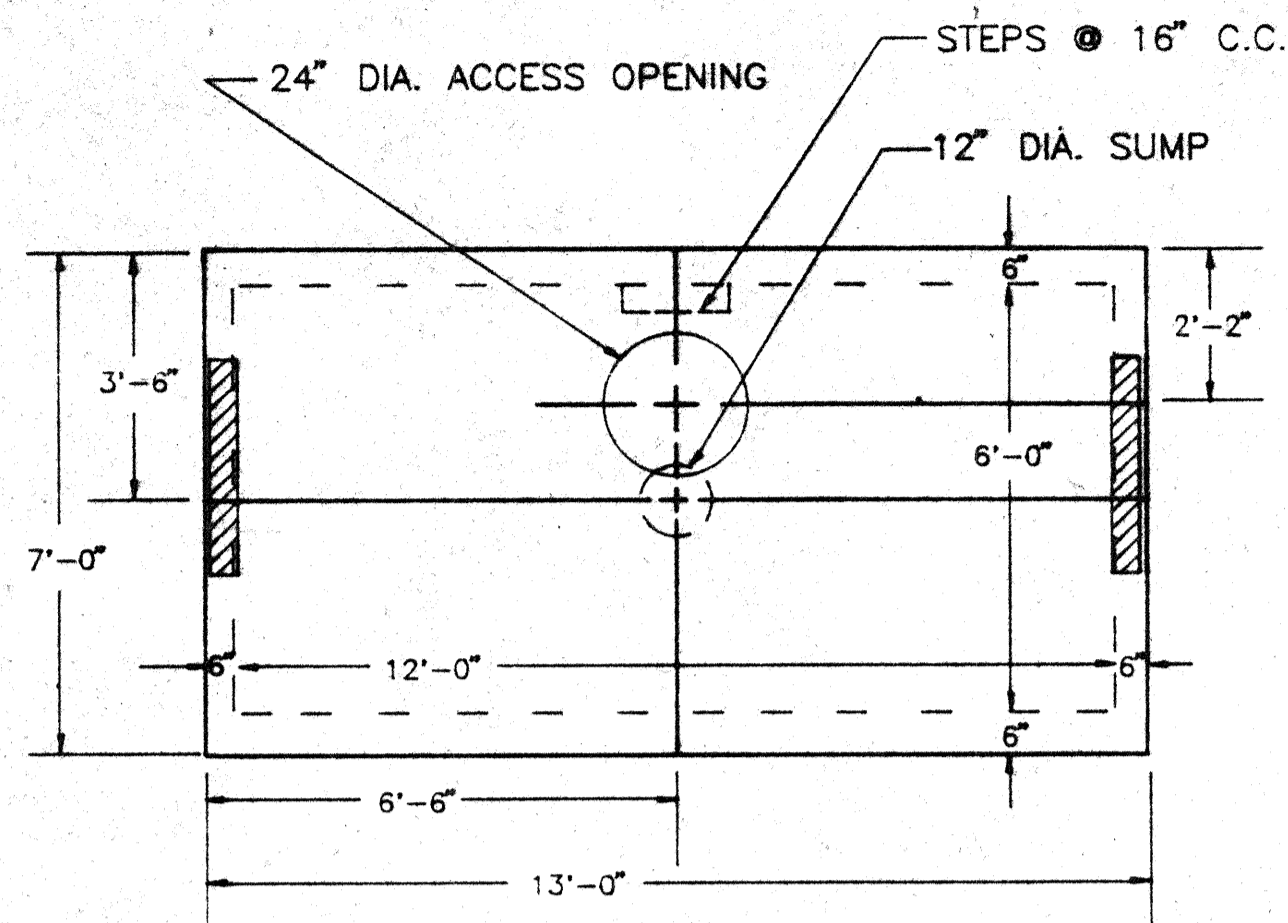

TOP VIEW

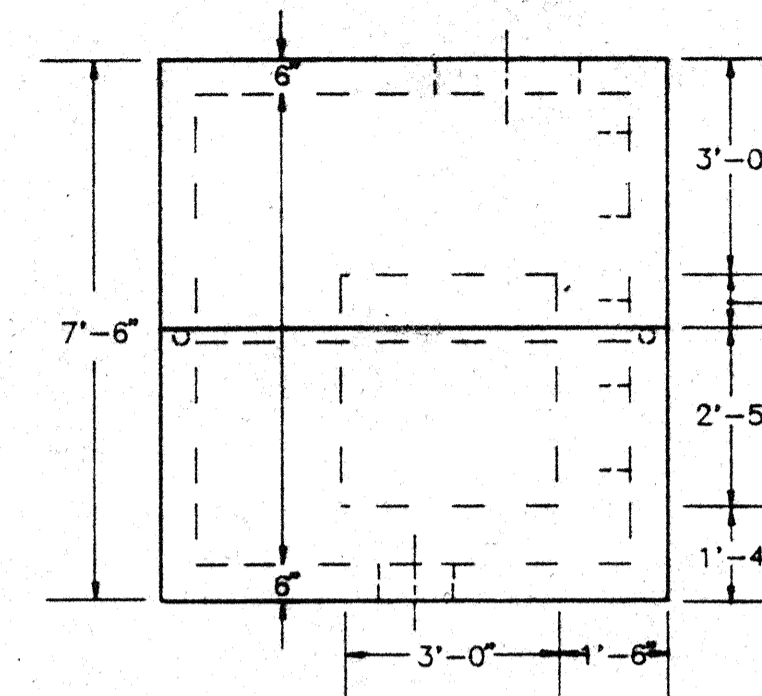

RIGHT SIDE VIEW

HOLLOW KNOCKOUT AREA FOR SERVICE LINE

M12MV METER VAULT: TRAFFIC BEARING

SPECIFICATIONS FOR METER VAULTS

TYPE OF DESIGN: TRAFFIC-BEARING RECTANGULAR VAULTS

CONCRETE

METER VAULT WALLS AND TOP ARE 6" THICK. ALL CONCRETE HAS A COMPRESSION STRENGTH OF NOT LESS THAN 4,500 PSI @ 28 DAYS.

REINFORCING

ALL REINFORCING STEEL IS #5 AND #6 GRADE 60 DEFORMED REBAR STRATEGICALLY PLACED SO AS TO ALLOW THE STRUCTURE TO WITHSTAND NORMAL EARTH PRESSURES.

JOINTS

ALL JOINTS SHALL BE SEALED WITH A FLEXIBLE BUTYL RESIN SEALANT MANUFACTURED BY CON-SER.

KNOCKOUTS


EACH METER VAULT SHALL HAVE ONE (1) KNOCKOUT WITH DIMENSIONS OF 3'-0" x 3'-0" ON EACH END WALL. THE KNOCKOUT OPENINGS SHALL EXTEND FROM APPROXIMATELY THREE (3) FEET TO SIX (6) FEET BELOW THE TOP OF THE METER VAULT. THE THICKNESS OF THE CONCRETE WALL IN THE KNOCKOUT AREA IS TWO (2) INCHES, ALLOWING FOR EASY ENTRY OF THE WATER LINES INTO THE VAULT AFTER IT HAS BEEN SET IN THE EXCAVATION.

SUMP

A 12" DIAMETER THRU SUMP SHALL BE CENTRALLY LOCATED IN THE BOTTOM OF ALL VAULTS.

INSTALLATION

THE CONTRACTOR SHALL BE RESPONSIBLE FOR SUPPLYING A STABLE EXCAVATION, ACCESSIBLE FROM ONE SIDE AND HAVING A FIRM AND LEVEL BOTTOM. HE SHALL ALSO BE RESPONSIBLE FOR CEMENTING AROUND WATER LINES AT THE POINTS OF ENTRY TO THE VAULT AND BRINGING THE FRAME AND COVER TO GRADE IN A MANNER EXHIBITING GOOD ENGINEERING PRACTICES.

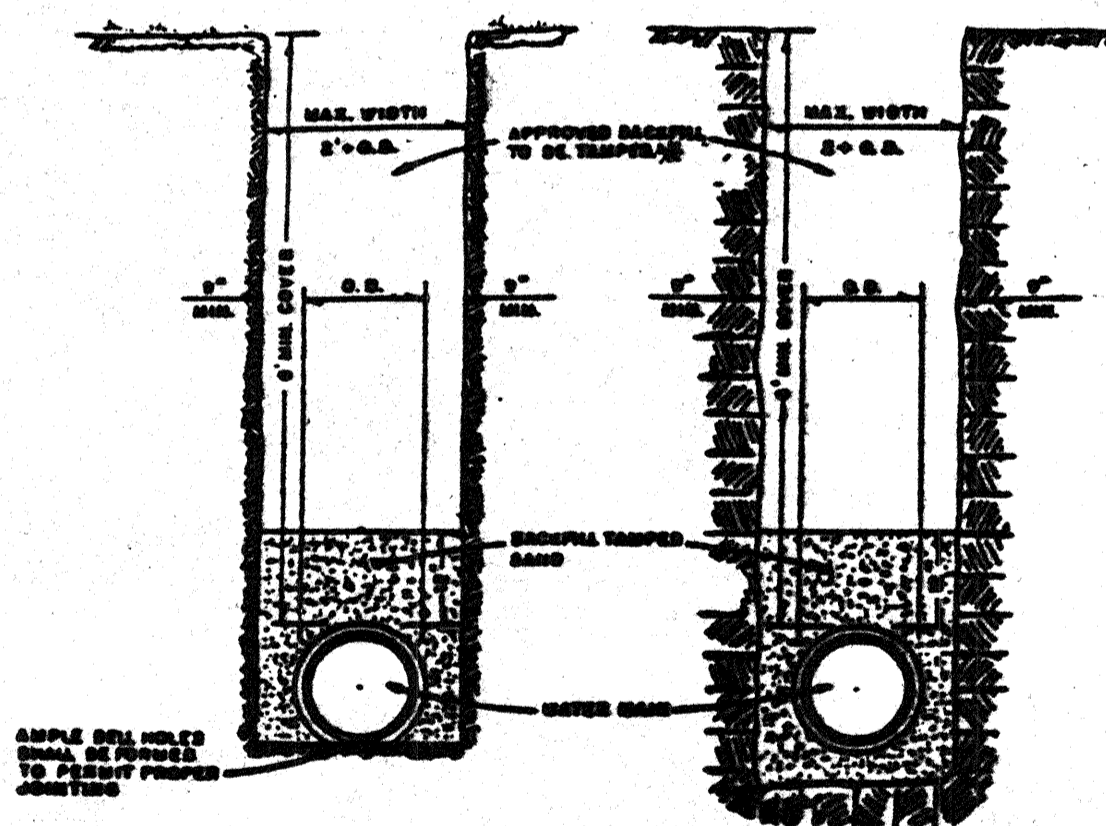

IN EARTH IN ROCK WATER MAIN TRENCH DETAIL

\*PREMIUM BACKFILL, CONSISTING OF SAND, SHALL BE USED BENEATH ALL PAVEMENT AND SIDEWALKS

REVISIONS			NO.	DATE	BY
NO.	DATE	BY			

LOW SERVICE DISTRICT  
DEPARTMENT OF PUBLIC UTILITIES  
DIVISION OF WATER  
CLEVELAND, OHIO

SUBJECT: ERIESIDE AVENUE (ACCESS ROAD)  
DETAILS

DRAWN BY: \_\_\_\_\_ SCALE: \_\_\_\_\_  
DESIGNED BY: \_\_\_\_\_  
CHECKED BY: \_\_\_\_\_ DATE: \_\_\_\_\_

No. B-2828

Turner  
URS CONSULTANTS  
POLYTECH


DESIGNED BY: D.R.B.	DATE: 5/28/91
DRAWN BY: D.R.B.	DATE: 5/28/91
CHECKED BY: E.D.V.	DATE: 5/28/91

DOCK 24W  
SLIP EXTENSION  
CLEVELAND-CUYAHOGA COUNTY  
PORT AUTHORITY

UTILITY DETAILS


No.	Date	By	Revision
1	3/2/92	PGP	CONSTRUCTION ISSUE

CHIEF ENGINEER	SHEET NO. 12A of 13
DIRECTOR	PROJECT NO.

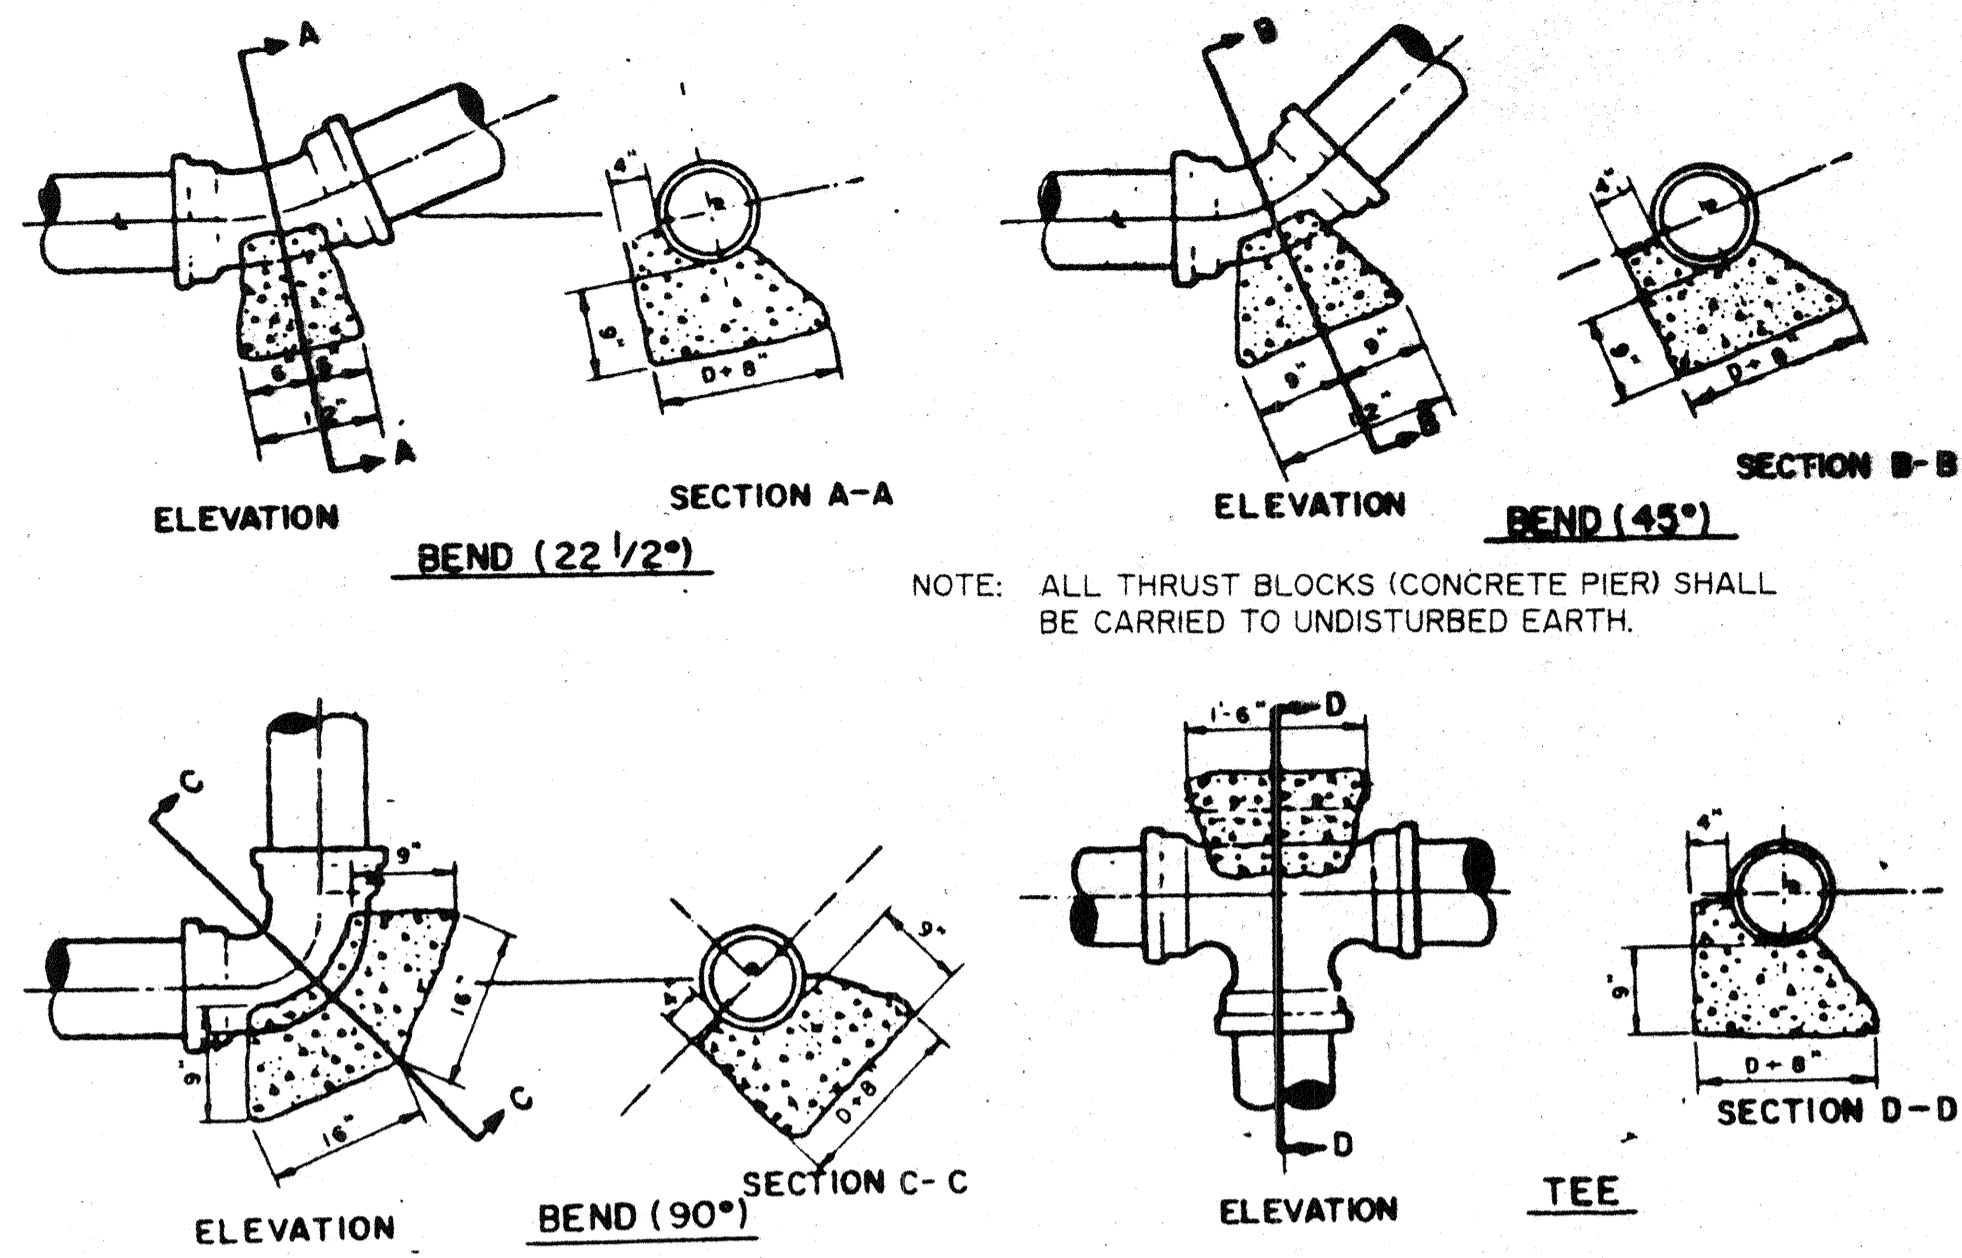

NOTE: ALL THRUST BLOCKS (CONCRETE PIER) SHALL BE CARRIED TO UNDISTURBED EARTH.

TYPICAL THRUST BLOCK INSTALLATION

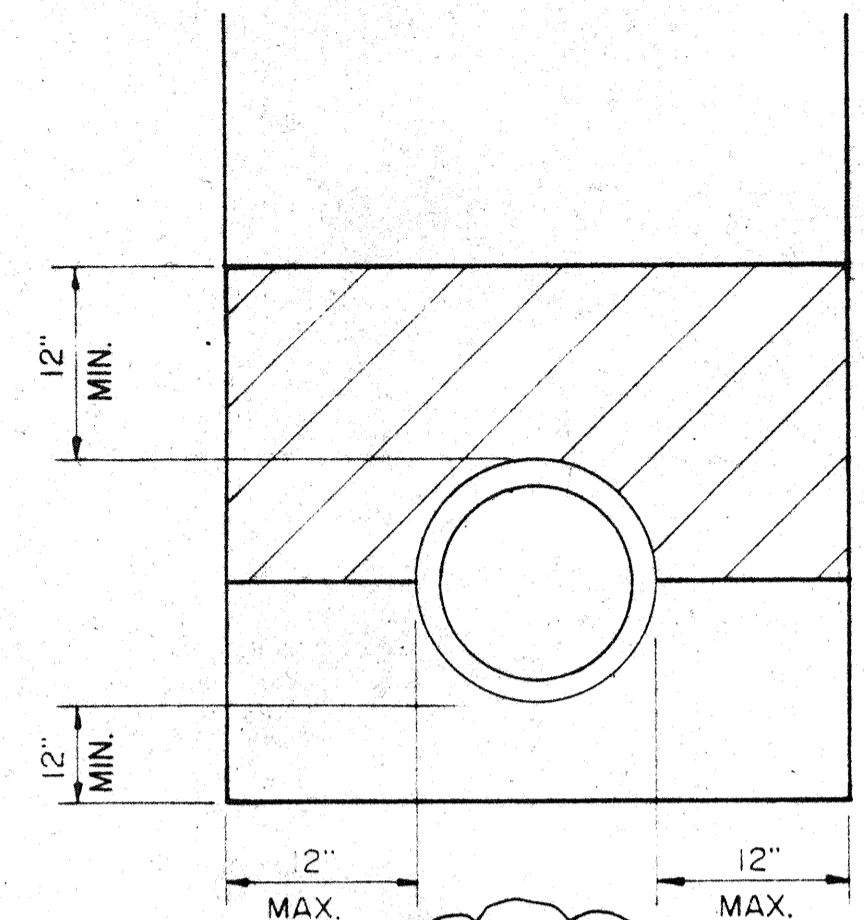


**SEWER PIPE BEDDING**

BEDDING MATERIAL AGGREGATE NO. 57, COMPACTED TO 95% MAX. LAB. DRY WEIGHT AS PER AASHTO T99.


APPROVED GRANULAR BACKFILL MATERIAL, COMPACTED IN ACCORDANCE TO SPECIFICATION SECTION 02200.

STORM SEWER MANHOLE SCHEDULE

MANHOLE NUMBER	STATION & OFFSET	INVERT ELEVATIONS		REMARKS:
		IN	OUT	
1	STA. 10+22± (60.0'R)	EXISTING SEWER 576.5 ±	24"W 576.50 MATCH CROWN OF EXISTING SEWER	CATCH BASIN FRAME & GRATE
2	STA. 9+15 (60.0'R)	24"E 574.36	24"N 574.35	MANHOLE FRAME & COVER
3	STA. 10+85 (78.0'L)	24"S 571.75	24"W 571.74	MANHOLE FRAME & COVER
4	STA. 10+85 (50.0'L±)	24"SE 571.9 ±	24"N 571.86 MATCH CROWN OF EXISTING SEWER	CATCH BASIN FRAME & GRATE



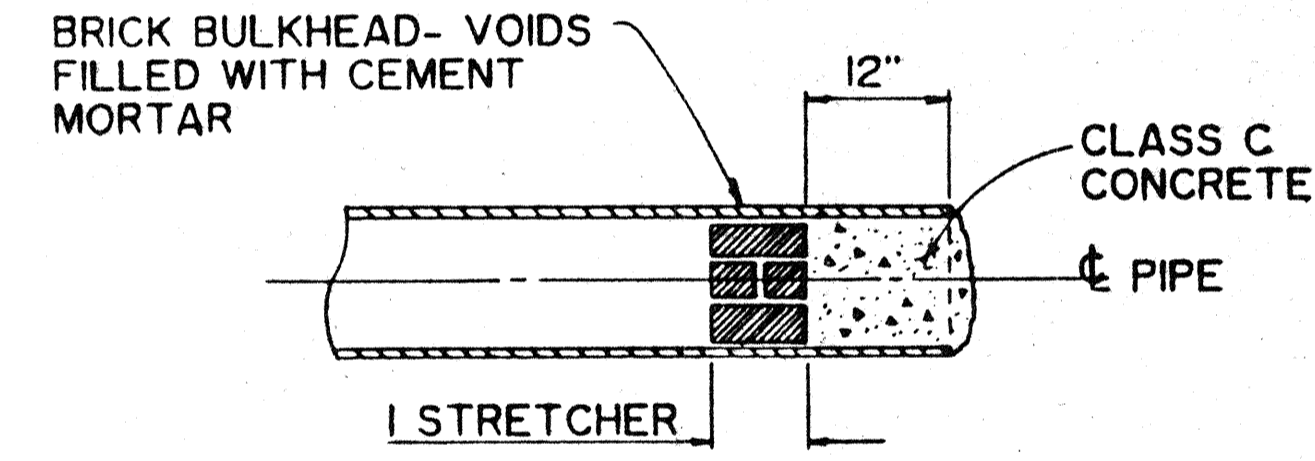


PLUGGING ABANDONED PIPE

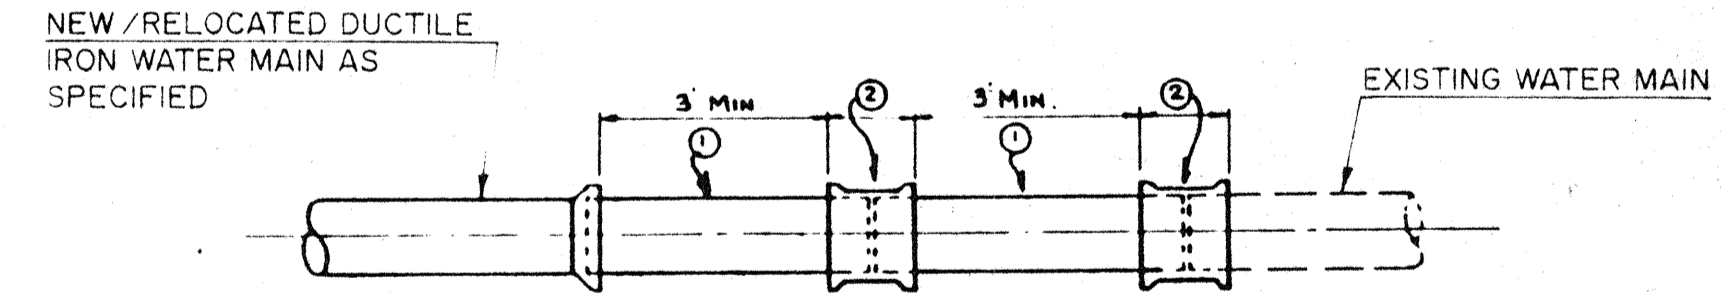

- PLAIN END X PLAIN END DUCTILE IRON PIPE AS SPECIFIED (CUT-TO-SUIT)
- DUCTILE IRON CLASS 350 OR CAST IRON CLASS 250 RETAINED MECHANICAL JOINT SOLID SLEEVES (SHORT PATTERN). TWO MAY BE REQUIRED AS SHOWN.

**SLEEVE - IN CONNECTION**

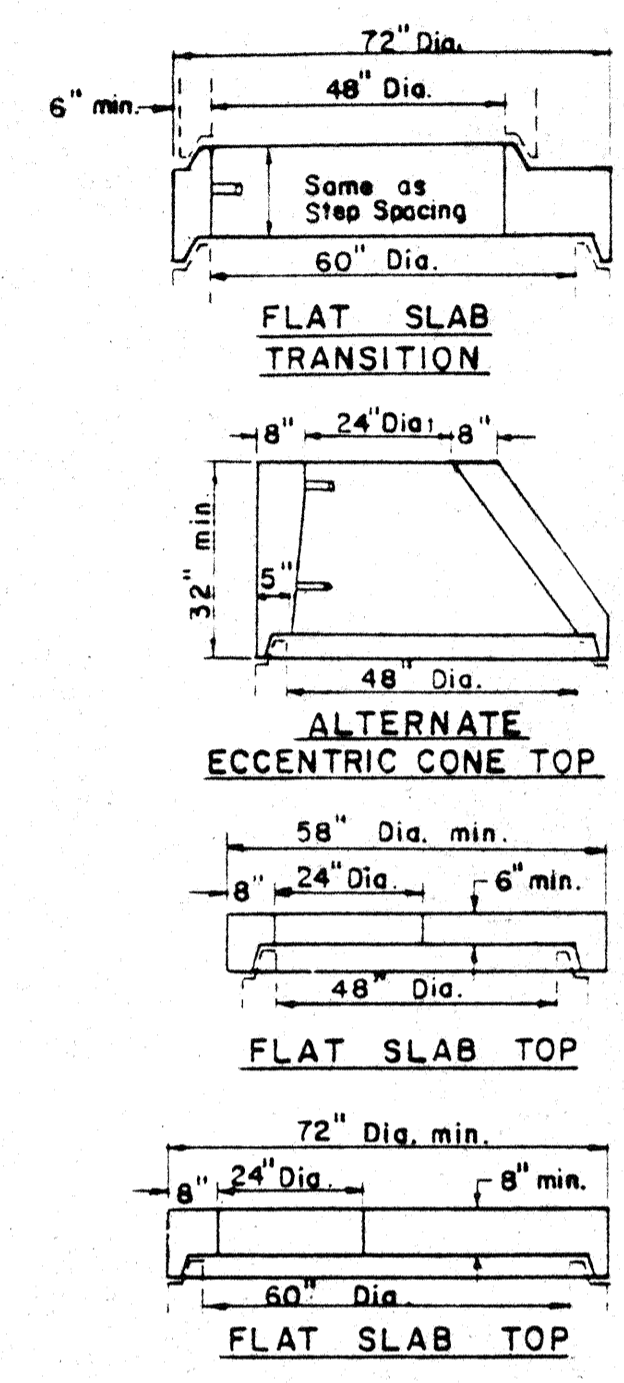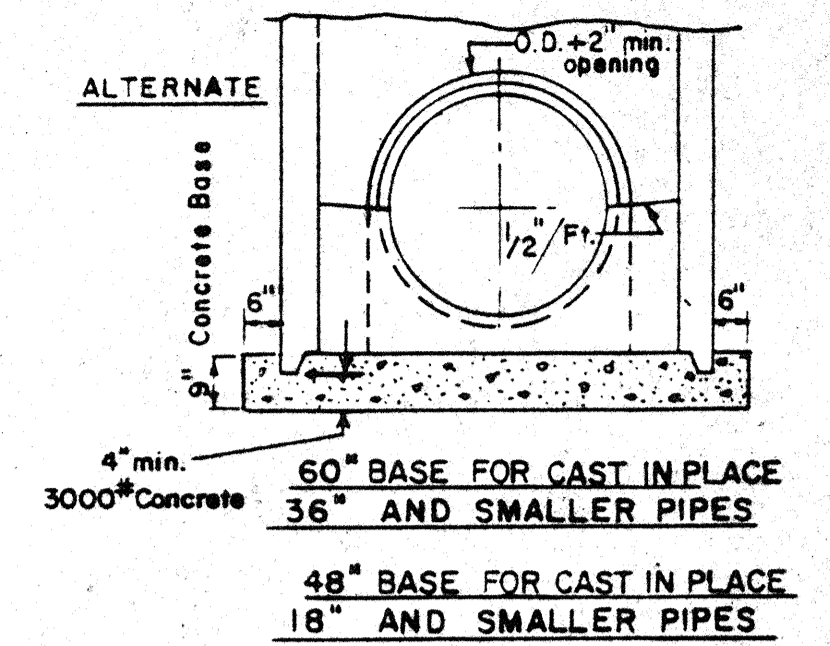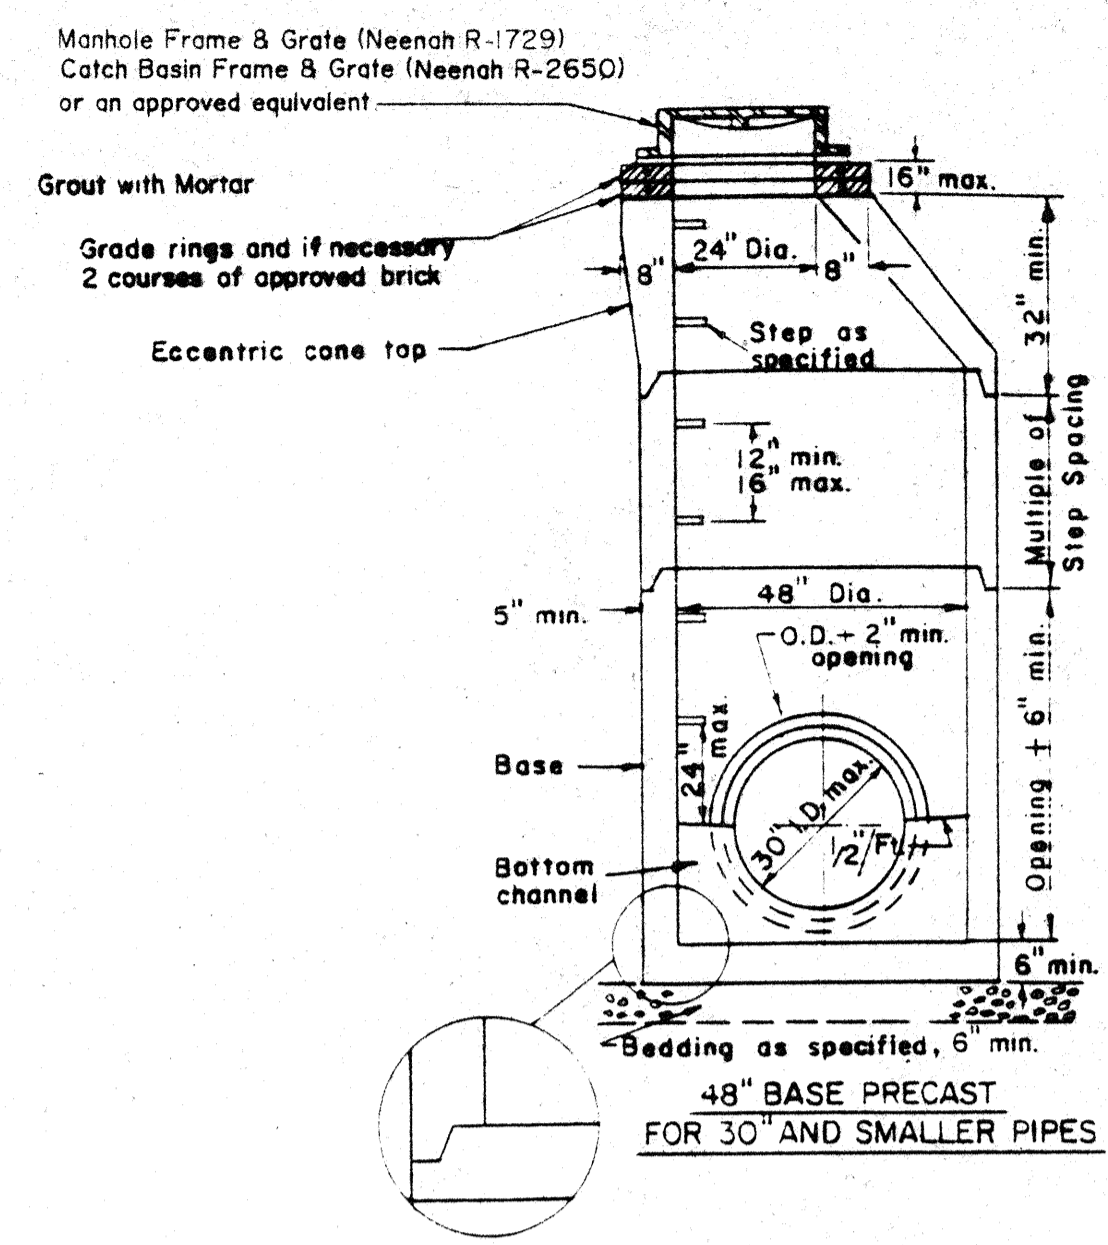

**NOTES:**

Sections of the precast manhole shall be cast and assembled with either all tongue or all groove ends up. Lift holes may be provided in each section for handling.

**TOP AND TRANSITION (or reducer)**  
Sections may be either eccentric cone, concentric cone or flat slab.

**BASES for Manholes** are shown with monolithic floor and riser which may be cast in one or two operations. A permissible alternate is to cast and ship the floor and barrel separately. Openings for inlet and outlet pipes shall be provided, either when the unit is cast or later, to meet project requirements. Bottom channels may be formed of concrete precast in the base or by field construction. Bases may also be poured in place.

**OPENINGS IN RISER SECTIONS** for 18" and smaller inlet pipes shall be prefabricated. Flexible connections shall be provided for sanitary and combined sewers.

**BRICK** shall conform to ASTM C-32.

**JOINT SEAL** between precast manhole sections on sewers shall be resilient and flexible gasket joints per A.S.T.M. C443 - or latest edition.

**MATERIALS** for bases and other precast sections, including reinforcement not specified hereon, shall comply with the specifications.

**LANDING PLATFORMS** as shown on the Landing Details shall be installed in manholes that are over 28 feet deep to the invert with a maximum vertical spacing of 20 feet.

**PRECAST MANHOLE** shall conform to the requirements of A.S.T.M. C 478.

**SEAL** lift holes with approved concrete plugs and bit.

PRECAST CONCRETE MANHOLE

REVISIONS			LOW SERVICE DISTRICT	
NO.	DATE	BY		
			DEPARTMENT OF PUBLIC UTILITIES	
			DIVISION OF WATER	
			CLEVELAND, OHIO	
			SUBJECT: ERIESIDE AVENUE (ACCESS ROAD)	
			DETAILS	
			DRAWN BY: _____	SCALE: _____
			DESIGNED BY: _____	
			CHECKED BY: _____	DATE: _____
				No. B-2829

<table border="1"> <tr> <th>No.</th> <th>Date</th> <th>By</th> <th>Revision</th> </tr> <tr> <td>2</td> <td>3/2/92</td> <td>PGP</td> <td>CONSTRUCTION ISSUE</td> </tr> <tr> <td>△</td> <td>5/28/91</td> <td></td> <td>REVISED TITLE OF DETAIL</td> </tr> </table>	No.	Date	By	Revision	2	3/2/92	PGP	CONSTRUCTION ISSUE	△	5/28/91		REVISED TITLE OF DETAIL	<p>Turner URS CONSULTANTS POLYTECH</p>	DESIGNED BY: D.R.B.      DATE: 5/91	<p>DOCK 24 W SLIP EXTENSION CLEVELAND-CUYAHOGA COUNTY PORT AUTHORITY</p>	<p>UTILITY DETAILS</p>
	No.	Date	By	Revision												
	2	3/2/92	PGP	CONSTRUCTION ISSUE												
	△	5/28/91		REVISED TITLE OF DETAIL												
DRAWN BY: M.A.C.      DATE: 5/91																
CHECKED BY: E.D.V.      DATE: 5/91																
SCALE: _____																
			CHIEF ENGINEER: _____ DIRECTOR: _____	SHEET NO. 13 of 13 PROJECT NO. _____												